Attachment #3



633 E. Broadway, Suite 103 Glendale, CA 91206-4311 Tel. (818) 548-2140 Fax (818) 240-0392 glendaleca.gov

DESIGN REVIEW BOARD RECORD OF DECISION

| Meeting Date | April 14, 2022 | DRB Case No. | PDR 2111714 |
|--------------|----------------|--------------|-----------------------|
| | | Address | 924 Old Phillips Road |
| | | Applicant | Nareg Khodadadi |

Project Summary:

The applicant is proposing to demolish an existing 2,243 square-foot, one-story, single-family dwelling and attached two-car garage (built in 1967) and to construct a new 3,363 square-foot, two-story, single-family dwelling with an attached 440 square-foot, two-car garage on a 9,250 square-foot property located in the R1R (Restricted Residential, Floor Area District II) Zone.

Design Review:

| Board Member | Motion | Second | Yes | No | Absent | Abstain |
|--------------|--------|--------|-----|----|--------|---------|
| Lockareff | Х | | Х | | | |
| Minas | | | Χ | | | |
| Simonian | | | | | Х | |
| Tchaghayan | | Х | Χ | | | |
| Welch | | | Χ | | | |
| Totals | | | 4 | 0 | | |

Return for Redesign

Condition:

DRB Decision

- 1. Reduce the height of the roof at the entry porch to align its fascia with that of the onestory portion of the house. Lower the front door height correspondingly.
- 2. Restudy the design of the stair tower area at the front façade, possibly creating a break between the first and second levels, revising the window pattern and/or shifting the location of the stairs, to provide better integration of the two sides of the primary façade.
- 3. Shift the second floor mass to the southwest to soften the overall building mass and provide some massing relief to the adjoining property.

- 4. Revise the roof design to create better-integrated forms, particularly at the stair tower, second level, and the entry to avoid the appearance of multiple independent roof forms. This may, at least in part, be accomplished through the implementation of conditions 1 to 3.
- 5. That the driveway and entry walkway be repaved with a decorative material consistent with the design, with consideration given to a permeable paving material.
- 6. Revise the balcony railing designs to be more compatible with the traditional features of the design.
- 7. Clarify the final design of the front doors. If they will not be simple single-light glazed doors, drawings and/or cut sheets must be submitted for staff review and approval.
- 8. Use opaque, non-reflective panels at the garage door.
- 9. Eliminate or significantly reduce the size of the second floor balcony at the rear façade from the proposal and redesign it to enhance privacy of adjacent properties. Applicant is to provide with the resubmittal for the board's review sight line studies, site section drawings, and photos that illustrate the potential privacy impacts of the front and rear balconies at the second floor.
- 10. Indicate exterior lighting locations on the elevation drawings and provide cut sheets of the proposed fixtures for staff review and approval. Avoid overlighting the building facades and specify fixtures that will avoid light spillover onto adjoining properties.
- 11. Work with Building & Safety and Planning staff to obtain all necessary permits and approvals to legalize, modify, or rebuild the existing unpermitted retaining wall at the rear of the property.

| DRB Staff Member | Vista Ezzati, Planner | |
|------------------|-----------------------|--|
| | | |

Notes:

All resubmittals require a DRB application and fee payment. According to Section GMC 30.47.075, projects submitted after 180 days following the DRB's decision date are to be considered as new projects and must submit a new DRB application and all corresponding materials, including new mailing list and labels.

NEW HOUSE AIVAZIAN RESIDENCE 924 OLD PHILLIPS RD. GLENDALE, CA 91207

PROJECT INFORMATION

PROJECT LOCATION 924 OLD PHILLIPS RD. GLENDALE, 91207

AIVAZIAN

924 OLD PHILLIPS RD.


GLENDALE, 91207


PROJECT DESIGNER DESIGNNRK 213 N. ORANGE STREET, STE. E GLENDALE, 91203 OFFICE: 818.823.7286 FAX: 888.424.8125

E-MAIL: INFO@DESIGNNRK.COM

SITE PLAN KEYED NOTES

- PROPERTY LINE
- NEW SFD FLOOR LINE GARAGE LINE
- EXT'G DRIVEWAY TO REMAIN
- EXT'G LANDSCAPING TO REMAIN
- NEW CONC. PATIO (NOT COVERED)
- DIRECTION OF SHEET FLOW 2%
- NEW CONC. LANDING WITH STEPS
- EXT'G PLANTER WALL TO REMAIN
- EXT'G BLOCK WALL TO REMAIN
- EXT'G DRIVEWAY LINE
- NEW LANDSCAPE

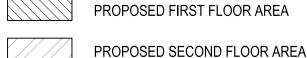

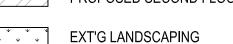

NEW 2 CAR GARAGE

CITY OF GLENDALE PLANNING NOTES

"NO OAK, BAY OR SYCAMORE TREES ARE ON THE PROPERTY OR WITHIN 20 FEET OF THE PROPERTY"

RETAINING WALLS, POOLS, SPAS, JACUZZIS, FENCES, REQUIRE SEPARATE PERMIT.

SITE MAP



SHEET INDEX

| ARCHITEC | TURAL SHEETS: |
|------------------|---------------------------|
| A0.1 | COVER SHEET & SITE PLAN |
| A0.2 | SECURITY & GREEN NOTES |
| A1.1 | EXT'G SITE PLAN |
| A1.2 | NEIGHBORING PROPERTIES |
| A2.1 | PROPOSED FIRST FLOOR PLAN |
| A2.2 | PROPOSED SECOND ROOF PLAN |
| | DOOR / WINDOW SCHEDULE |
| A2.3 | PROPOSED ROOF PLAN |
| A2.4 | EXT'G ROOF PLAN |
| A3.0 | EXT'G ELEVATIONS |
| A3.1 | EXTERIOR ELEVATIONS |
| A3.2 | EXTERIOR ELEVATIONS |
| A4.1 | BUILDING SECTIONS |
| <u>TITLE 24:</u> | |
| T1 | ENERGY CALCULATIONS |
| T2 | ENERGY CALCULATIONS |

ENGINEERING SHEETS:

| S-1.0 | GENERAL NOTES |
|-------|-------------------|
| S-1.1 | GENERAL NOTES |
| S-1.2 | DETAILS |
| S-2.1 | FOUNDATION PLAN |
| S-2.2 | ROOF FRAMING PLAN |
| S-3.1 | DETAILS |

DETAILS

PROJECT FLOOR PLAN AREA & DATA

| LOT AREA | 9,250± SQ. FT. |
|-----------------------------|----------------|
| NEW SINGLE FAMILY RESIDENCE | 3,363 SQ. FT. |
| FIRST FLOOR | 2,665 SQ. FT. |
| SECOND FLOOR | 698 SQ. FT. |
| NEW 3 CAR GARAGE | 440 SQ. FT. |
| TOTAL LIVING AREA | 3 363 SQ FT |

| FLOOR AREA RATIO MAX. 40% TOTAL MAX 3,710 SQ. FT. | TOTAL LIVING AREA: 3,363 SQ. FT. LOT AREA (9,250 SQ. FT.) | 36 % |
|---|---|------|
| LOT COVERAGE RATIO | LOT COVEDACE (2.105.SOLET.) | |

| LOT COVERAGE RATIO MAX. 40% - 3,700 SQ. FT. | LOT COVERAGE (3,105 SQ. FT.) LOT AREA (9,250 SQ. FT.) | 34 % |
|--|---|------|
| LANDSCAPE RATIO MIN. 40% - 3,700 SQ. FT. | LANDSCAPED AREA (4,880 SQ. FT.) LOT AREA (9,250 SQ. FT.) | 53 % |

| ZONING | F | R1R II |
|-------------------|---------------------|----------|
| APN | 5649-002 | 2-039 |
| OCCUPANCY | RESIDENCE GARAGE | R-3 U |
| CONSTRUCTION TYPE | | V-B |
| YEAR BUILT | | 1967 |
| NUMBER OF STORIES | | 1 |
| FIRE ZONE | | YES |
| CA CLIMATE ZONE | | 9 |

PROJECT SHALL COMPLY W/ THE 2019 CBC, CMC, CEC, CPC, GFD & CALIFORNIA ENERGY CODE AS WELL AS THE 2020 GLENDALE BUILDING & SAFETY CODE. CBC SECTION 106.1.1

FIRE SPRINKLERS

SCOPE OF WORK

- NEW SINGLE FAMILY DWELLING (3,363 SQ. FT.) WITH 4 BEDROOMS AND 4.5 BATHROOMS
- NEW ATTACHED 2-CAR GARAGE (440 SQ. FT.)

NOTES

- A. SEPARATE PERMIT IS REQUIRED FOR THE FOLLWING:
 - 1. RETAINING WALL OF BLOCK FENCE WALL
 - 2. GRADING WORK
 - 3. SWIMMING POOL 4. A SEPARATE STRUCTURE
 - 5. SHORING
 - 6. DEMOLITION
- B. NO CHANGE IN GRADES ALLOWED

FIRE DEPT. NOTES

- 1. ADDRESS NUMBERS: APPROVED ADDRESS NUMBERS, BUILDING NUMBERS OR APPROVED BUILDING IDENTIFICATION SHALL BE PLACED IN A POSITION THAT IS GIVING ACCESS TO AND WITHIN THE PROPERTY. THESE NUMBERS SHALL CONTRAST WITH THEIR BACKGROUND. ADDRESS NUMBERS SHALL BE ARABIC INCHES (102 MM) HIGH WITH A MINIMUM STROKE WIDTH OF 0.5 INCH (12.7 MM) AND SHALL BE ILLUMINATED IN AN APPROVED MANNER (IF NUMBERS ARE ON THE EXTERIOR). NUMBER HEIGHT AND STROKE WIDTH SHALL BE INCREASED AS NEEDED FOR LEGIBILITY BASED ON VISIBILITY DISTANCE.
- 2. FIRE SPRINKLERS: PROVIDE A COMPLETE AUTOMATIC FIRE SPRINKLER SYSTEM THROUGHOUT THE STRUCTURE INSTALLED IN ACCORDANCE WITH THE RECOMMENDATIONS OF NFPA 13D AND THE REQUIREMENTS OF THE GLENDALE FIRE DEPARTMENT. FIRE SPRINKLER PLANS SHALL BE SUBMITTED WITHIN 30 DAYS OF ISSUANCE OF THE BUILDING PERMIT.
- 3. SMOKE DETECTORS: SMOKE DETECTORS SHALL BE WIRED TO THE BUILDING ELECTRICAL SYSTEM, BE EQUIPPED WITH BATTERY BACKUP, AND EMIT A SIGNAL WHEN BATTERIES ARE LOW. SMOKE ALARMS SHALL BE INTERCONNECTED, SO THAT THE ACTIVATION OF ONE ALARM WILL ACTIVATE ALL OTHER SMOKE DETECTORS.
- 4. CARBON MONOXIDE DETECTORS: SHALL BE INSTALLED OUTSIDE OF EACH SEPARATE DWELLING UNIT SLEEPING AREA IN THE IMMEDIATE VICINITY OF THE BEDROOM (2) AND ON EVERY LEVEL OF A DWELLING UNIT INCLUDING BASEMENTS. ALARMS SHALL BE HARDWIRED FROM THE BUILDING POWER SUPPLY AND EQUIPPED WITH BATTERY BACKUP. DETECTORS SHALL MEET U.L. 2034 AND /OR NFPA 720 STANDARDS. 2019 CALIFORNIA RESIDENTIAL CODE CHAPTER 3 SEC.
- 5. EGRESS: ALL REQUIRED EXITS ARE TO BE OPENABLE FROM THE INSIDE WITHOUT KEY OR SPECIAL KNOWLEDGE OR EFFORT.
- 6. <u>REQUIRED FIRE DEPARTMENT INSPECTIONS</u> FOR THIS PROJECT ARE LISTED BELOW. FOR ALL INSPECTIONS, CALL 818-548-4810
- 7. FIRE PERMITS: THE FOLLOWING PERMITS ARE REQUIRED FROM THE FIRE
- FUEL MODIFICATION / LANDSCAPING FOR HIGH FIRE HAZARD AREAS
- MAINTAIN EXISTING / PROVIDE FUEL MODIFICAITON ONLY NO FIRE DEPARTMENT REVIEW OR PERMITTING OF LANDSCAPE PLANS. ALL FUEL MODIFICATION / LANDSCAPING SHALL COMPLY WITH FIRE DEPARTMENT APPROVAL / PERMITTED LANDSCAPE PLANS.
- FIRE SPRINKLER OVERHEAD/UNDERGROUND ROUGH AND FLUSH (BEFORE COVERING ANY PIPING)
- FIRE SPRINKLER FINAL
- FIRE PREVENTION BUREAU FINAL (ADDRESS SIGNS, EGRESS, FIRE DEPARTMENT ACCESS, SMOKE DETECTORS, FUEL MODIFICATION, ETC.)
- 9. ADDITIONAL REQUIRED GFD INSPECTIONS: FOR INSPECTIONS, CALL 818-548-4810, FIRE DEPARTMENT INSPECTIONS FOR THIS PROJECT ARE: FIRE PREVENTION BUREAU FINAL (ADDRESS SIGNS, EGRESS FIRE DEPARTMENT ACCESS, SMOKE DETECTORS.

GENERAL NOTES

THE CONTRACTOR SHALL VERIFY ALL DIMENSIONS, ELEVATIONS, GRADES, EXISTING STRUCTURES, AND FIELD CONDITIONS AT THE SITE, BEFORE COMMENCING WORK. HE SHALL IMMEDIATELY NOTIFY THE DESIGNER AND/OR OWNER.

TYPICAL DETAILS SHALL APPLY IN GENERAL CONSTRUCTION. WHERE NO DETAILS ARE GIVEN, THE CONSTRUCTION SHALL BE AS FOR SIMILAR WORK. OMISSIONS AND/ OR CONFLICTS AMONG THE VARIOUS ELEMENTS OF THE DRAWINGS, NOTES, SPECIFICATIONS, EXISTING STRUCTURES, AND/ OR FIELD CONDITIONS, SHALL BE BROUGHT TO THE ATTENTION OF THE DESIGNER, BEFORE PROCEEDING WITH THE WORK SO INVOLVED.

CONSTRUCTION WORK SHALL NOT CREATE DUST, DIRT, OR OTHER SUCH INCONVENIENCES TO THE OTHER TENANTS.

CONSTRUCTION OPERATION SHALL NOT BLOCK WALKWAYS, OR OTHER MEANS OF

REVISIONS:

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05/2020 DRAWN BY JOB NO. 20028

SHEET NO.



10'-0"

3/5/12

3/5,12

3.5:12

PROPOSED SITE PLAN AND ROOF PLAN

OLD PHILLIPS RD.

3,363 SQ. FT.

55'-9"


APRON & CURB SHALL BE

CONSTRUCTED PER PUBLIC

WORKS ENG. REQUEST.

SEPARATE PERMIT REQUIRED.

SETBACK LINE

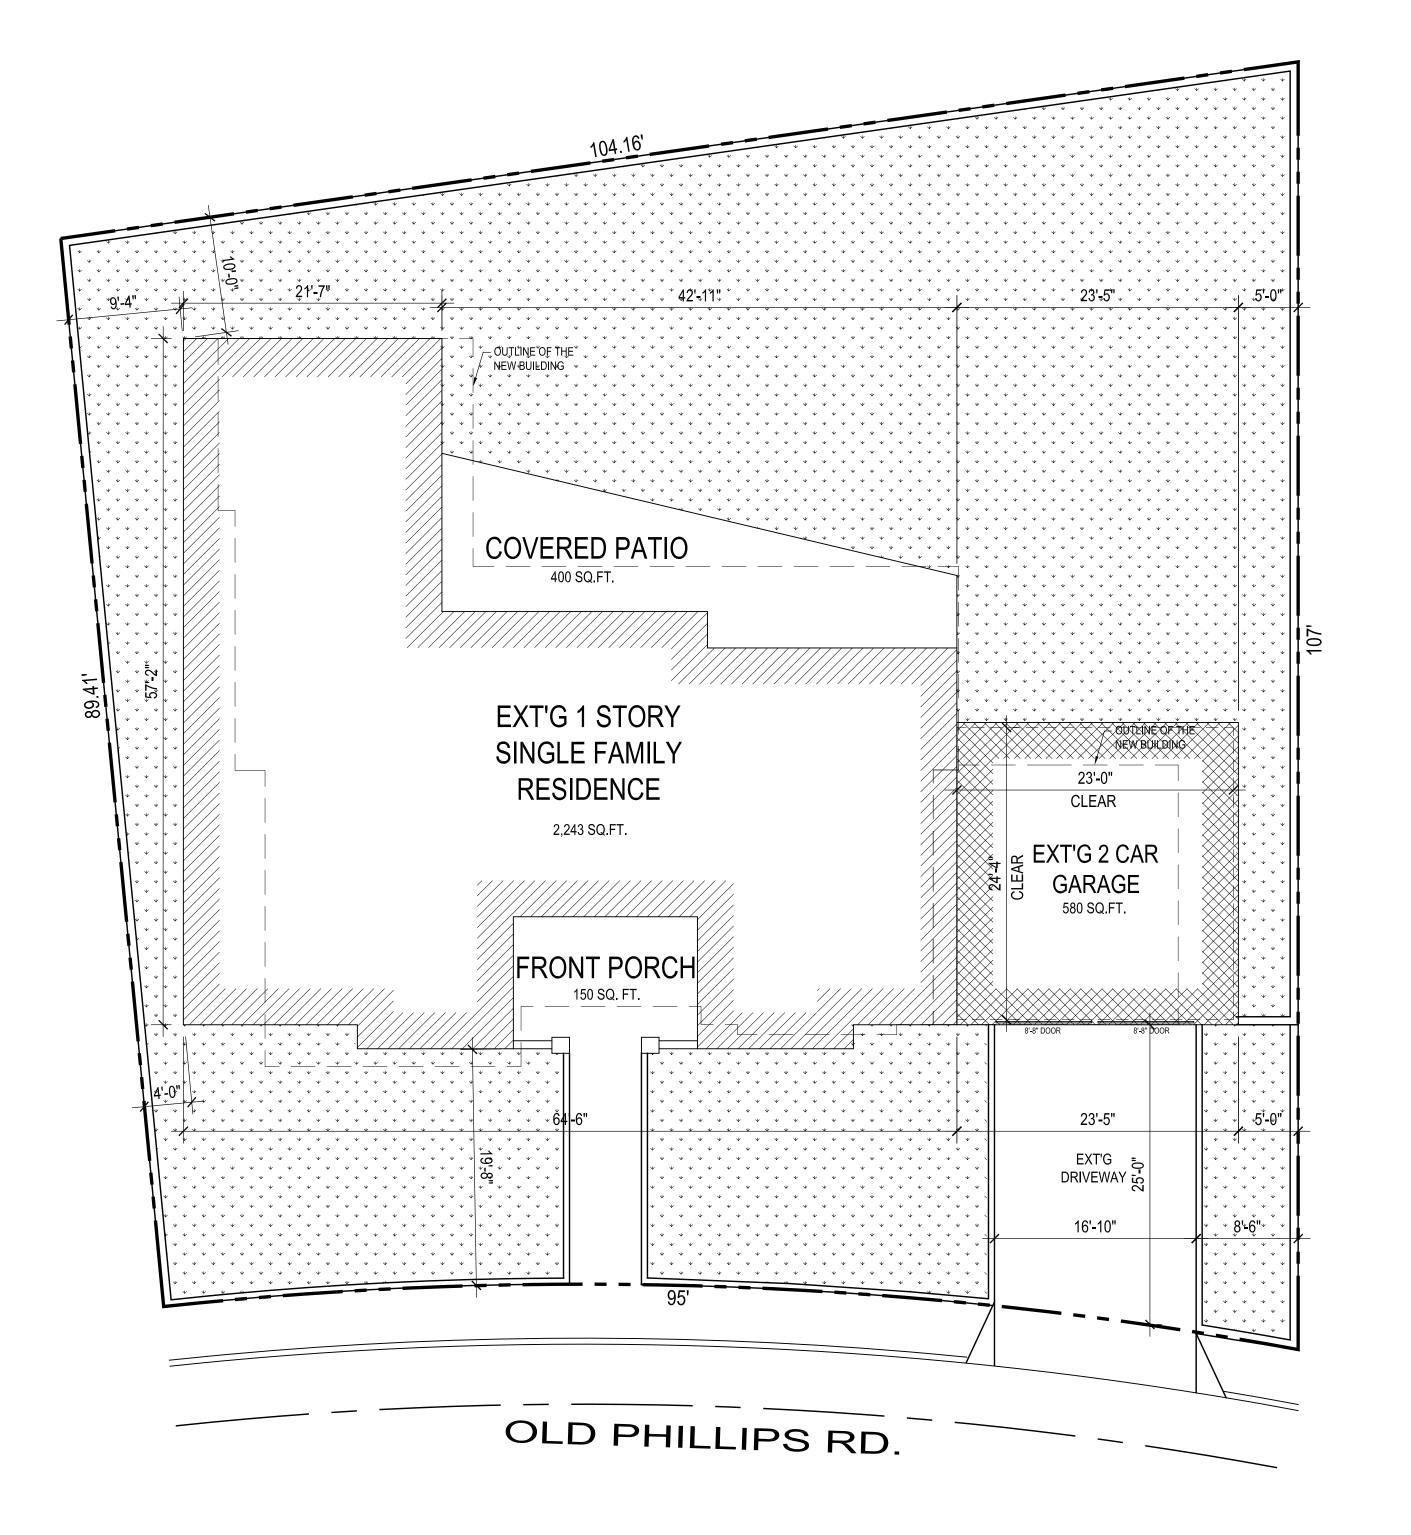

EXT'G SITE PLAN

SCALE: 1/8" = 1'-0"

SITE PLAN LEGEND

EXT'G RESIDENCE

EXT'G GARAGE

EXT'G LANDSCAPING

PROJECT FLOOR PLAN AREA & DATA

LOT AREA 9,250± SQ. FT.

EXT'G RESIDENCE 2,243 SQ. FT.

EXT'G 2 CAR GARAGE 580 SQ. FT.

EXT'G FRONT PORCH 150 SQ. FT.

EXT'G COVERED PATIO 400 SQ. FT.

TOTAL LIVING AREA 2,243 SQ. FT.

FLOOR AREA RATIO
MAX. 40%
TOTAL LIVING AREA: 2,243 SQ. FT.
LOT AREA (9,250 SQ. FT.)

24 %

LOT COVERAGE RATIO
MAX. 40% - 3,700 SQ. FT.

LOT COVERAGE (3,373 SQ. FT.)

LOT AREA (9,250 SQ. FT.)

<u>LANDSCAPE RATIO</u>
<u>MIN. 40% - 3,700 SQ. FT.</u>

<u>LANDSCAPED AREA (4,980 SQ. FT.)</u>

LOT AREA (9,250 SQ. FT.)

54 %

REVISIONS:

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DOSIDENTIAL + Commercial + Comm


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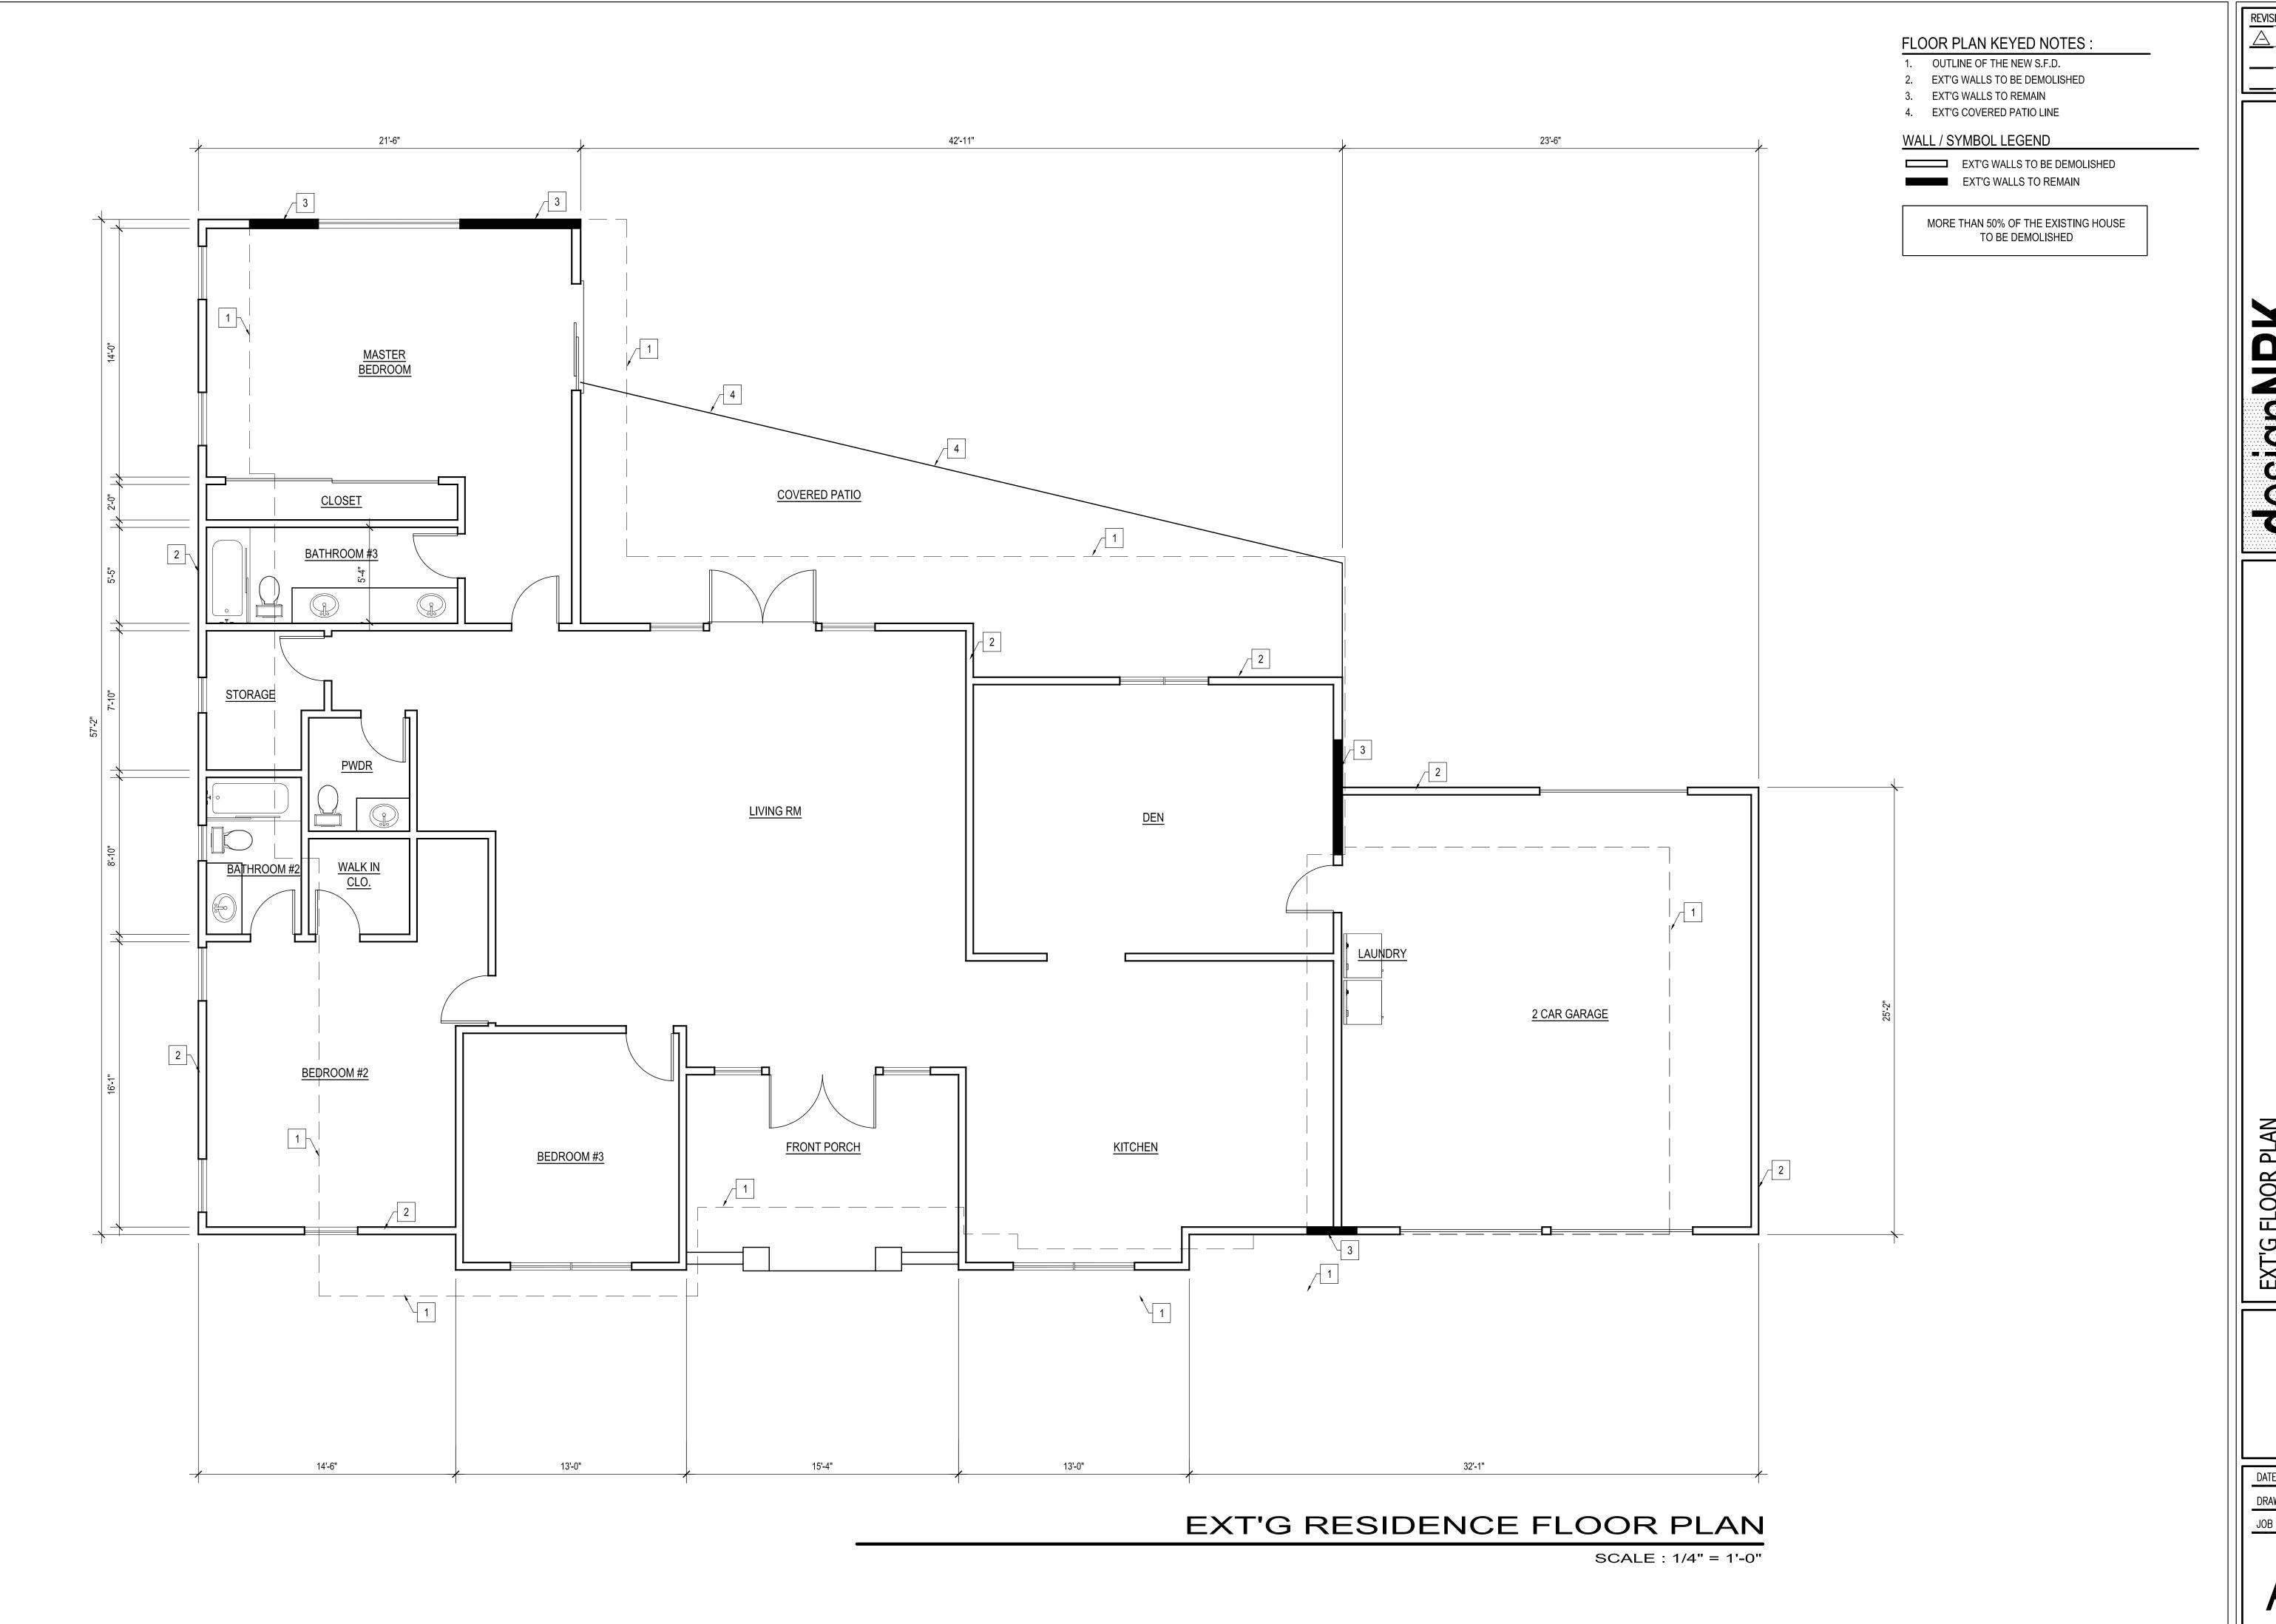
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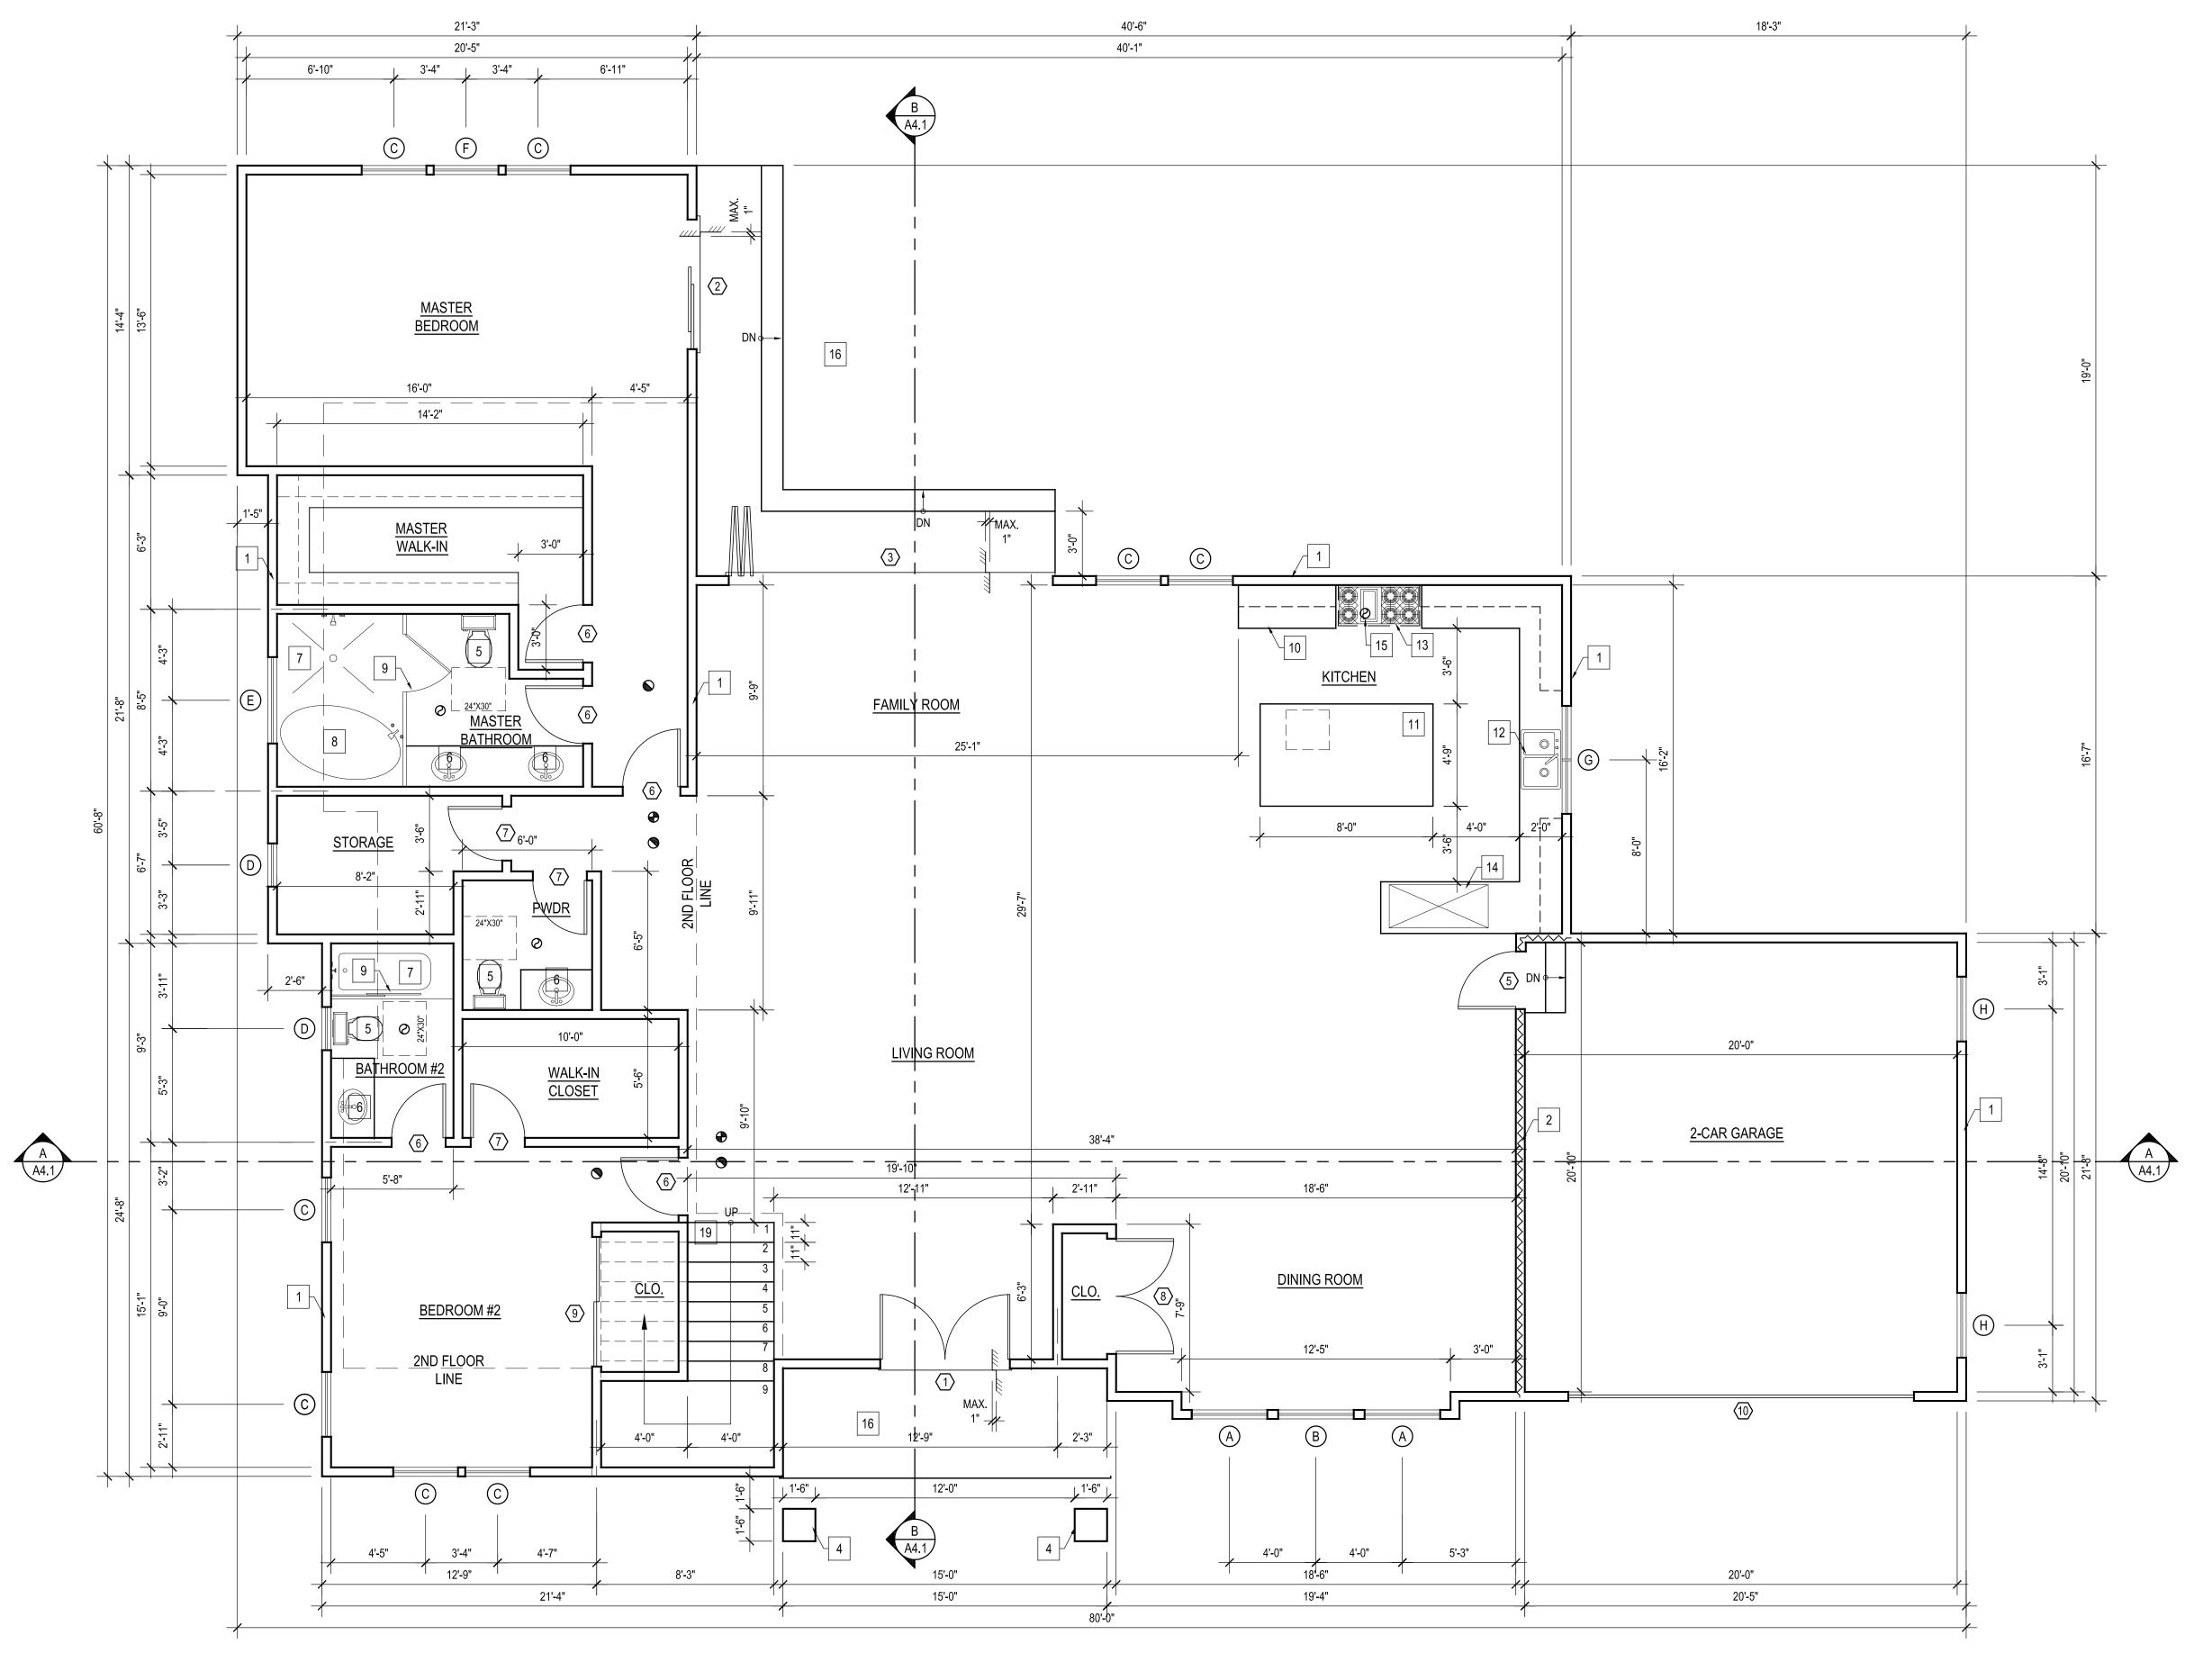
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05/2020



FLOOR PLAN KEYED NOTES:

(S.B.O.) SELECTED BY OWNER OR CONTRACTOR

NEW WALLS

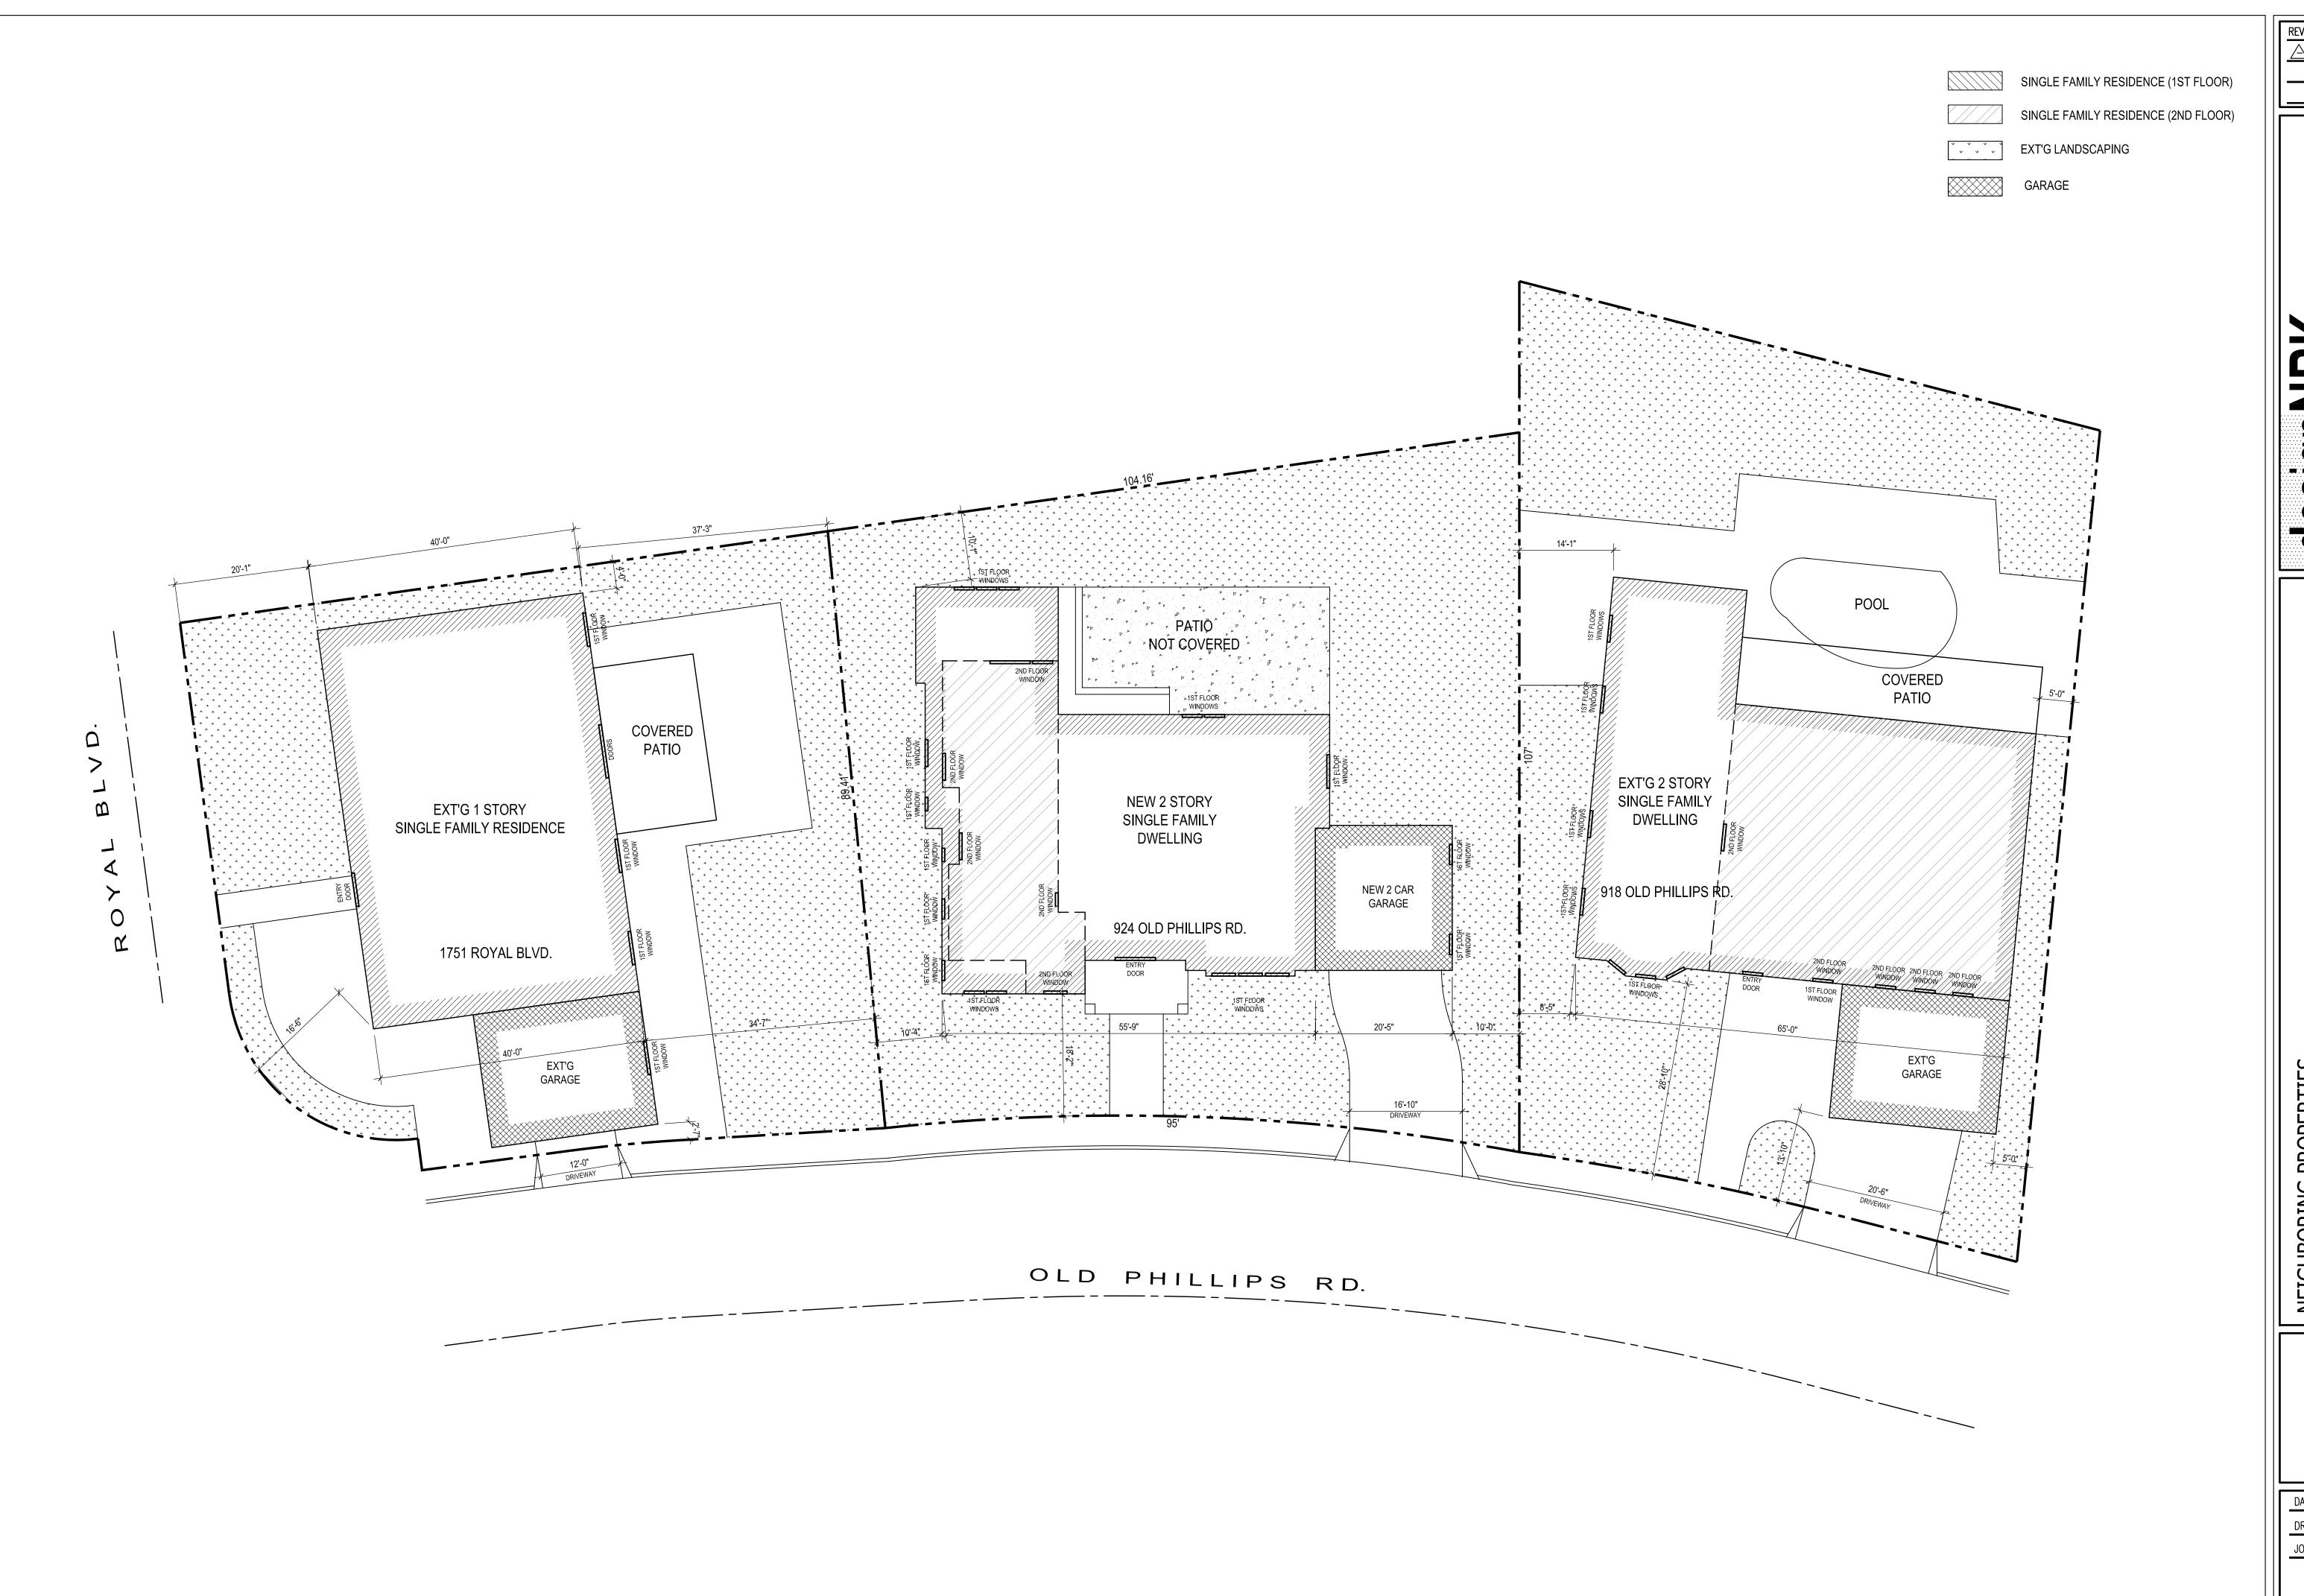- 2. 1-HOUR FIRE RATED WALL
- 3. LOW WALL 42" MIN. HT.
- 4. NEW COLUMN 5. NEW TOILET (S.B.O.)
- 6. NEW SINK (S.B.O.)
- 7. NEW TUB OR SHOWER (TILE TO CEILING)
- 8. NEW FREESTANDING TUB
- 9. CATEGORY II (TEMPERED GLASS) SHOWER DOOR & ENCL.FRAMELESS & SLIDER
- 10. NEW BASE AND UPPER CABINETS
- 11. NEW ISLAND-STONE TILE COUNTERTOP (S.B.O.)
- 12. NEW DOUBLE SINK
- 13. NEW RANGE
- 14. NEW REFRIGIRATOR
- 15. RANGE EXHAUST FAN (S.B.O.) MIN. 100 CFM
- 16. NEW CONC. LANDING MIN. WITH STEPS
- 17. NEW GUARDRAIL 42" MIN. HT.
- 18. NEW WASHER AND DRYER
- NEW STAIRCASE

WALL / SYMBOL LEGEND

NEW WALL

FIRE-RATED WALL - WITH 5/8" TYPE 'X' GYP BOARD ON THE GARAGE SIDE

© EXHAUST FAN CAPABLE OF PROVIDING 5 COMPLETE AIR CHANGES PER HOUR - 50

CARBON MONOXIDE DETECTOR

SMOKE DETECTOR SHALL BE INTERCONNECTED HARD-WIRED W/ BATTERY BACKUP AND SHALL BE INSTALLED IN ACCORDANCE WITH NFPA

GFCI - GROUND FAULT CIRCUIT INTERRUPTER

x'-xx" CEILING HEIGHTS

WATER FIXTURE

ON AND AFTER JANUARY 1, 2014, RESIDENTIAL BUILDINGS UNDERGOING PERMITTED ALTERATIONS, ADDITIONS, OR IMPROVEMENTS SHALL REPLACE NONCOMPLIANCE PLUMBING FIXTURES WITH WATER-CONSERVING PLUMBING FIXTURES. PLUMBING FIXTURE REPLACEMENT IS REQUIRED PRIOR TO ISSUANCE OF A CERTIFICATE OF FINAL COMPLETION BY BUILDING DEPARTMENT. SEE CIVIL CODE SECTION 1101.1

NON-COMPLIANT PLUMBING FIXTURES ARE DEFINED AS:

- A) ANY TOILET MANUFACTURED TO USE MORE THAN 1.6 GALLONS
- B) ANY SHOWER HEAD MANUFACTURED TO FLOW MORE THAN 2.5 GALLONS / MIN.
- C) ANY INTERIOR FAUCET MANUFACTURED TO FLOW MORE THAN 2.2
- ALL WATER FIXTURES TO BE LOW FLOW


PROPOSED FIRST FLOOR PLAN

SCALE : 1/4" = 1'-0"

REVISIONS:

FLOOR

05/2020 JOB NO.

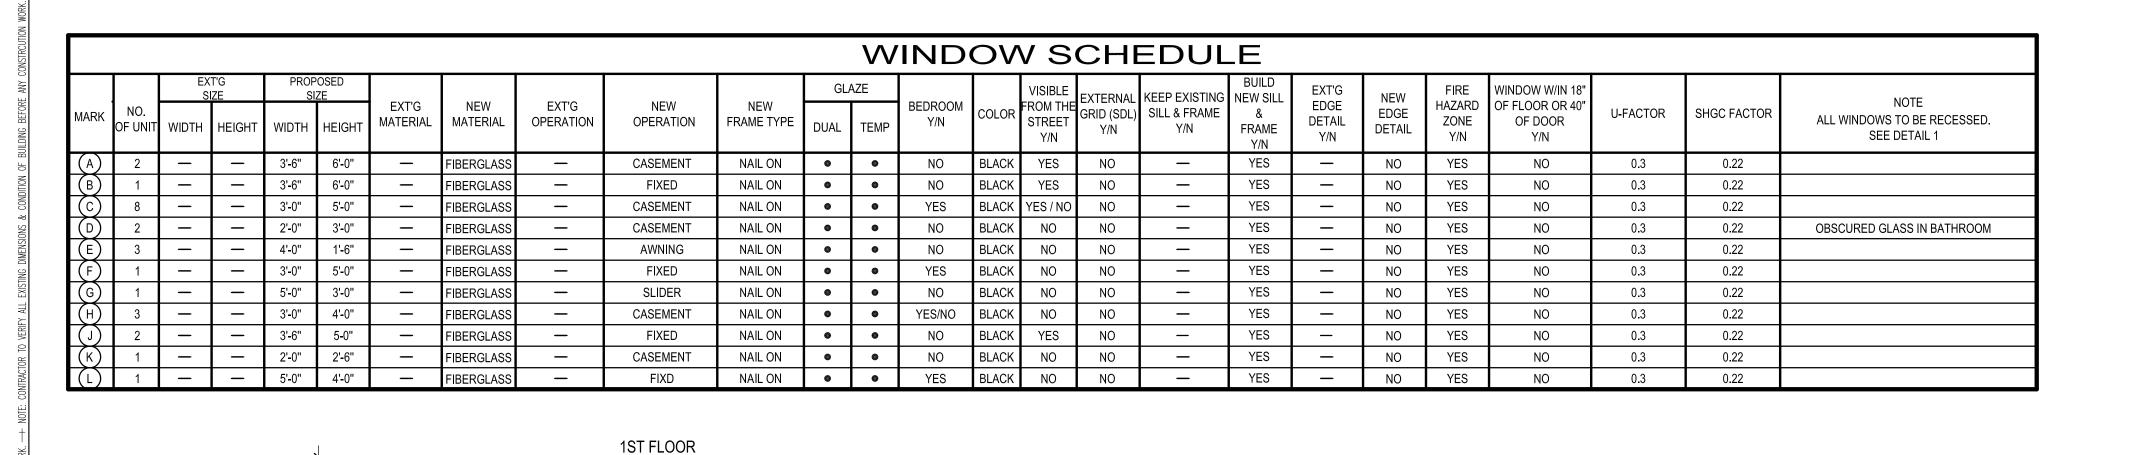

LINE

17'-3"

16'-5"

4'-10"

8'-10"

| | DOOR SCHEDULE | | | | | | | |
|---------------------|---------------|----------|-------|--------|------|-------|---------|--|
| NO | | NO. DOOR | | | | | | |
| MARK | | | SIZE | | GL/ | GLAZE | NOTES | |
| | UNIT | WD | HGT | THK | DUAL | TEMP | FINISH | |
| $\langle 1 \rangle$ | 1 | 6'-0" | 9'-0" | 1 3/4" | | • | PAINTED | ENTRY DOOR - DOUBLE WOOD DOORS |
| $\langle 2 \rangle$ | 1 | 6'-0" | 8'-0" | 1 3/4" | | • | PAINTED | EXTERIOR SLIDING DOOR |
| (3) | 1 | 15'-0" | 8'-0" | 1 3/4" | | • | PAINTED | EXTERIOR FOLDING DOOR |
| 4 | 2 | 6'-0" | 6'-8" | 1 3/4" | | • | PAINTED | FRENCH DOORS |
| (5) | 1 | 2'-8" | 6'-8" | 1 3/8" | | | PAINTED | 20-MIN FIRE RATED, SELF LATCHING, SELF CLOSING |
| 6 | 10 | 2'-8" | 6'-8" | 1 3/8" | | | PAINTED | INTERIOR DOOR |
| 7 | 3 | 2'-6" | 6'-8" | 1 3/8" | | | PAINTED | INTERIOR DOOR |
| (8) | 1 | 5'-4" | 6'-8" | 1 3/8" | | | PAINTED | INTERIOR DOOR |
| 9 | 1 | 6'-0" | 6'-8" | 1 3/8" | | | PAINTED | SLIDING CLOSET DOOR |
| (10) | 1 | 16'-0" | 8'-0" | 1 3/4" | | • | PAINTED | GARAGE DOOR |

WINDOW NOTES:

EXTERIOR GLAZING SHALL BE MULTI-PANE UNITS WITH A MINIMUM OF ONE TEMPERED PANE, OR GLASS BLOCK UNITS OR MINIMUM 20-MIN, RATED PER. TITLE-24 CALCULATIONS - ALL GLAZING TO HAVE NON-METAL FRAMES. PER. TITLE-24 - ALL GLAZING WILL HAVE EXTERIOR SHADING DEVICES, VIA BUG SCREENS PER. SHGC IN THE CALCULATIONS.

BEDROOM EGRESS WINDOWS HAVE A MINIMUM CLEAR OPENING AREA OF 5.7 s.f., A MINIMUM NET HEIGHT OF 24" AND MINIMUM NET WIDTH OF 20", AND A SILL HEIGHT NOT MORE THAN 44" MAXIMUM ABOVE THE FINISH FLOOR.


PROVIDE 32" WIDE DOORS TO ALL INTERIOR ACCESSIBLE ROOMS. (6304.1)

THE NFRC TEMPORARY LABEL DISPLAYED ON WINDOWS MUST REMAIN ON THE UNIT UNTIL THE FINAL INSPECTION HAS BEEN COMPLETED




(S.B.O.) SELECTED BY OWNER OR CONTRACTOR

- NEW WALLS
- 2. 1-HOUR FIRE RATED WALL
- 3. LOW WALL 42" MIN. HT.

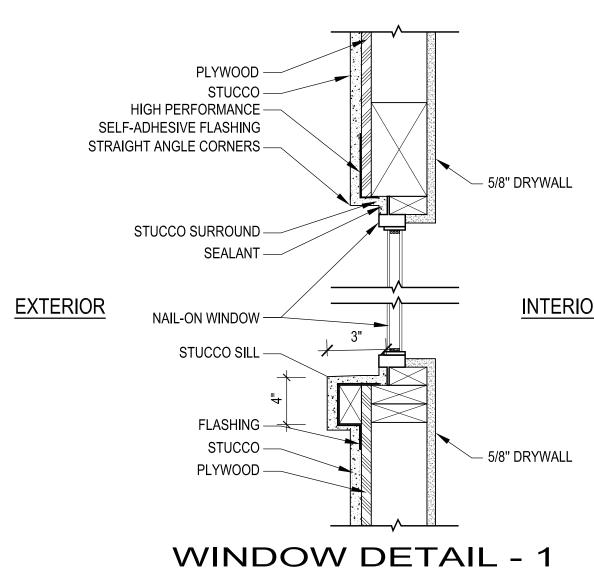

SCALE: NTS

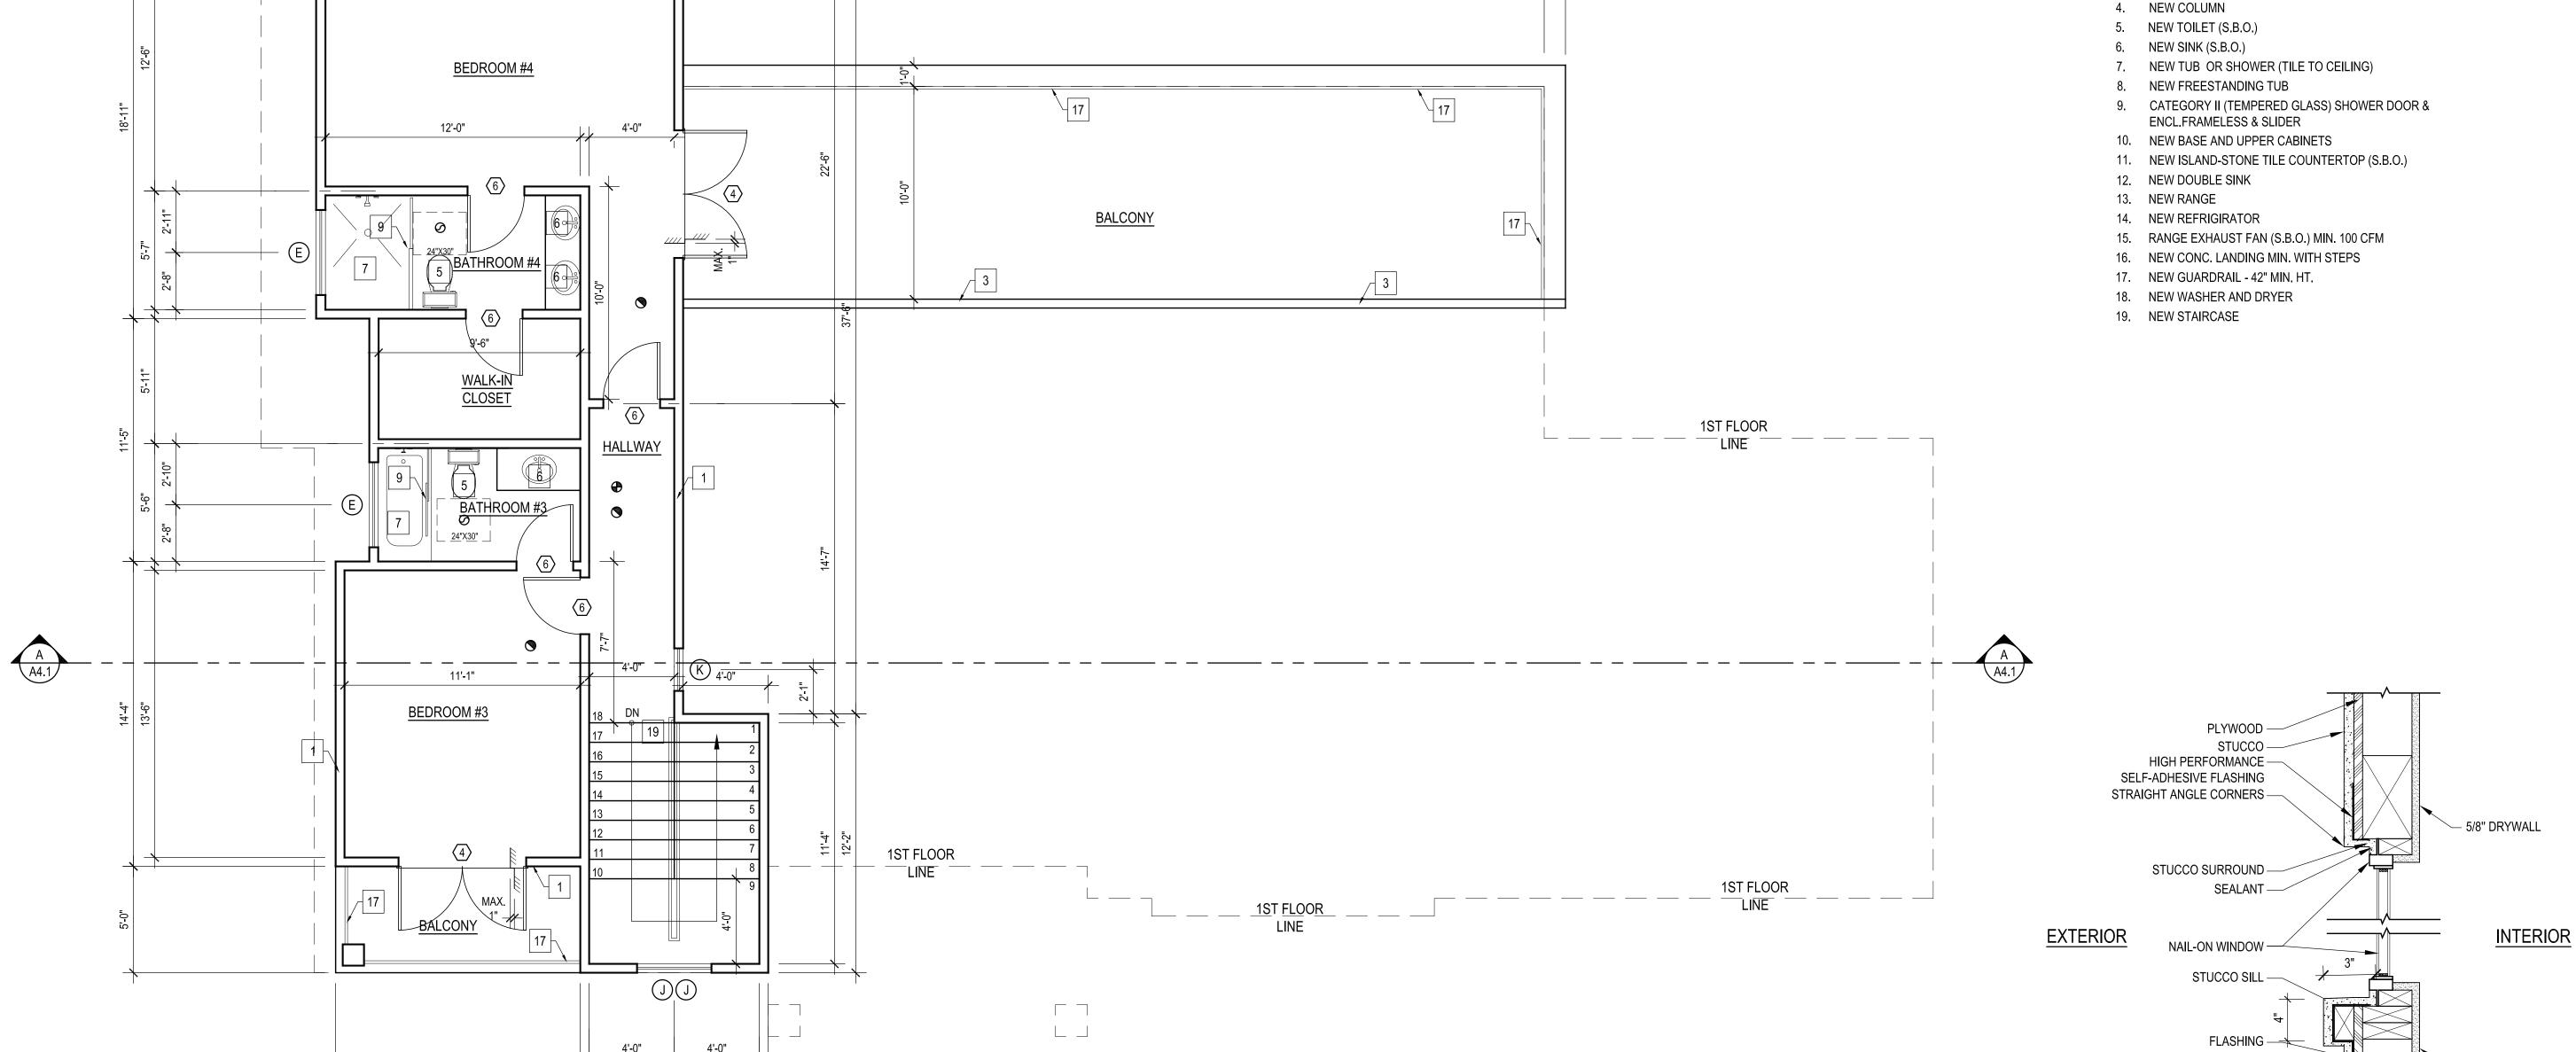


40'-6"

PROPOSED SECOND FLOOR PLAN SCALE : 1/4" = 1'-0"

05/2020 DRAWN BY: SHEET NO.

REVISIONS:

Gesign design

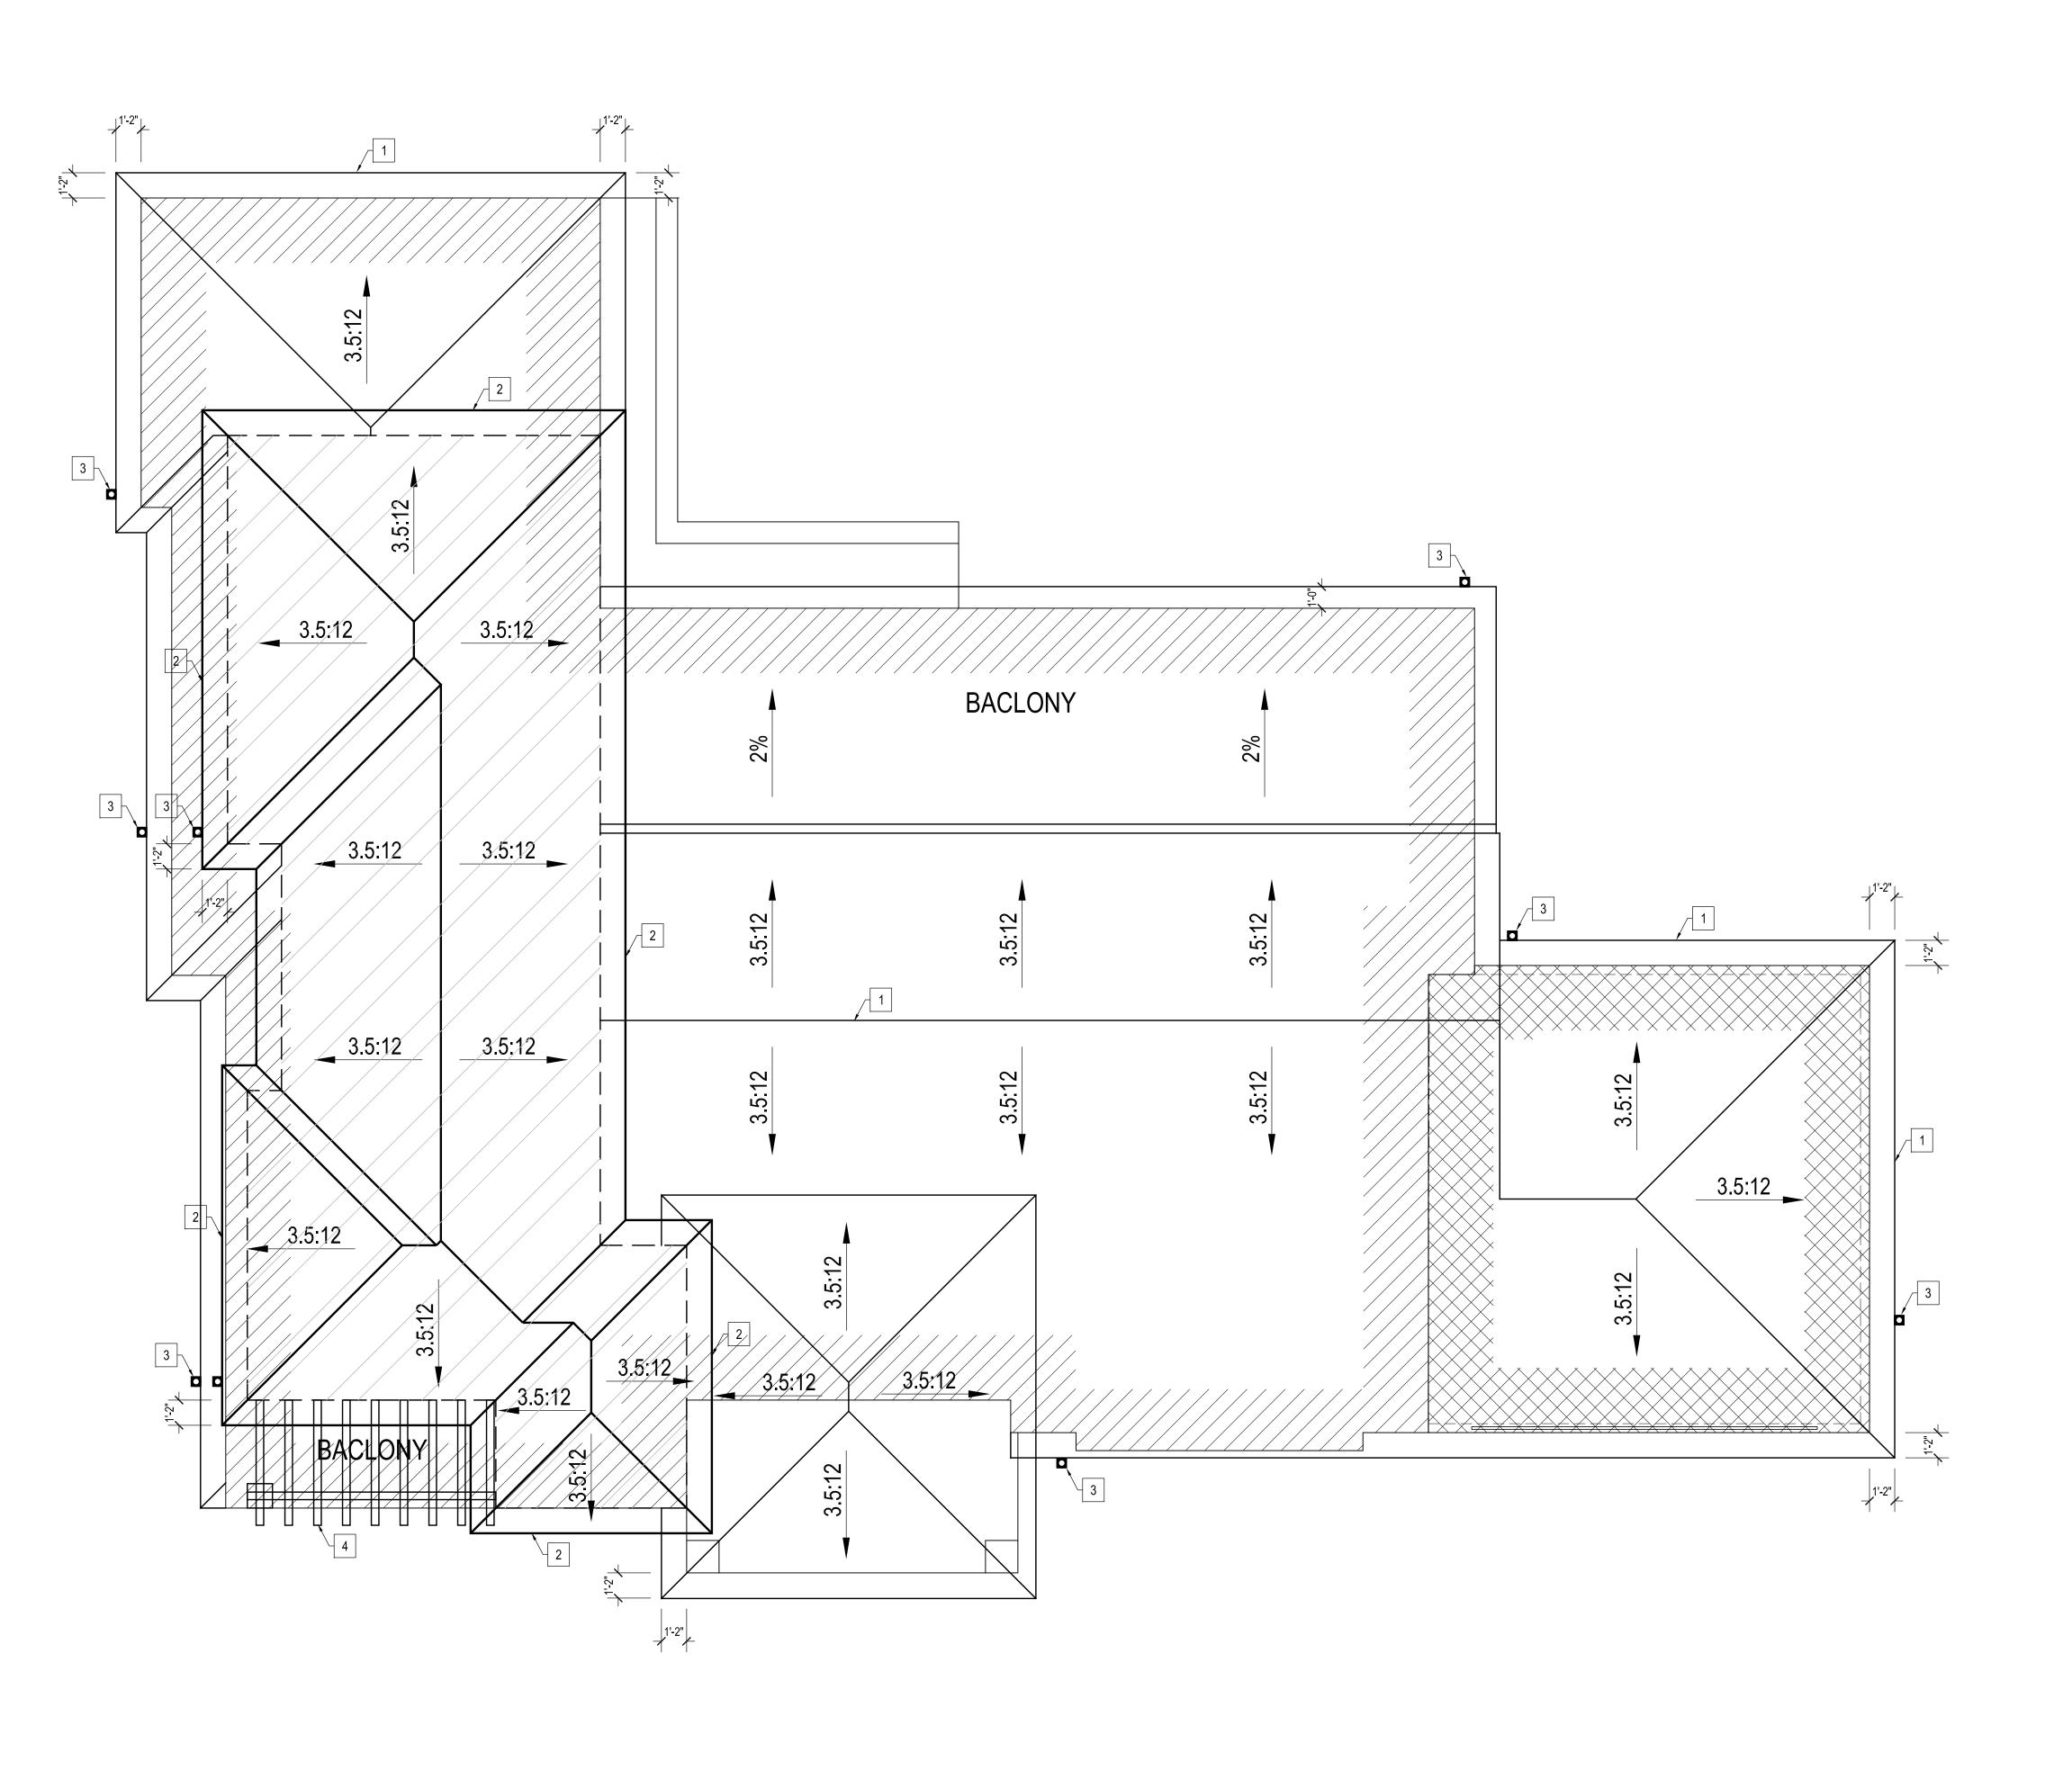

FLOOR PLAN KEYED NOTES:

1. FIRST FLOOR ROOF

2. SECOND FLOOR ROOF

3. DOWNSPOUT 4. TRELLIS

REVISIONS:

RESIDENCE

05/2020 20028



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 DATE:
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ELEVATION KEYED NOTES

- 1. EXT'G GRADE
- 2. NEW CLASS 'A' ROC
- LIGHT WEIGHT CONCR
- 3. NEW 7/8" SMOOTH STUCCO4. STONE VENEER
- 5. NEW COLUMN
- 6 NEW DOOD (CEE
- 6. NEW DOOR (SEE SCHEDULE)7. NEW WINDOW (SEE SCHEDULE)
- 8. NEW CONC. LANDING (WITH STEPS)
- 9. NEW RAILING 42" MIN. HT.10. LIGHT FIXTURE
- 11. DOWNSPOUT
- 12. STUCCO BAND
- 13. NEW CONC. WINDOW SILL 1-1/2" x 3"
- 14. NEW TRELLIS

LIGHT FIXTURE SCHEDULE

. ONE-LIGHT OUTDOOR WALL FIXTURE . BLACK WITH CREAM COLORED GLASS

"EASY HANGER" SYSTEM

. BACK PLATE MEASURE 4 1/4" W x 5 5/8" H

OUTLET BOX: 3-1/2"

. 1 100w MAX MEDIUM BASE

. PAINTED BRONZE WITH CLEAR SEEDY GLASS . EXTENDS: 7-1/2", HEIGHT FROM CENTER OF

. FEATURES THOMAS LIGHTINGS EXCLUSIVE

DESCRIPTION


THOMAS LIGHTING SL91047

OUTDOOR LIGHT FIXTURE

QUANT**I**TY

FRONT (NORTH) ELEVATION

SCALE : 1/4" = 1'-0"

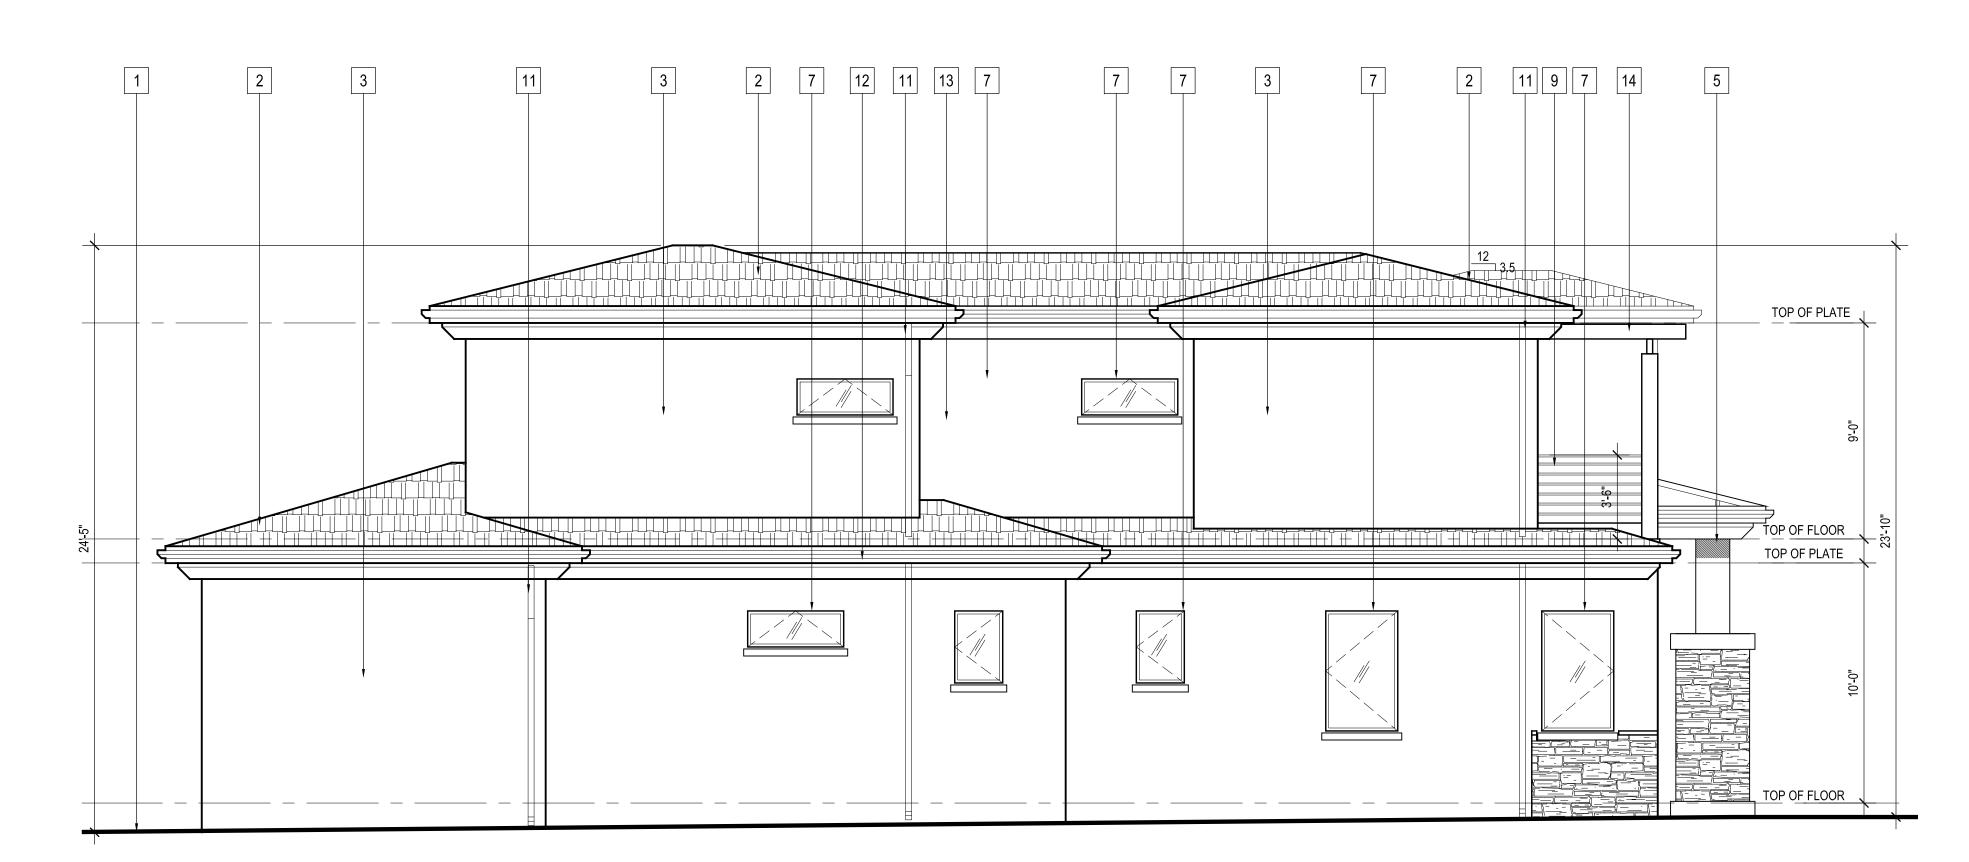

SCALE : 1/4" = 1'-0"

| ROOFING | |
|------------|-----------|
| CONCRETE | |
| | |
| OTH STUCCO | 1 9 K ~ L |

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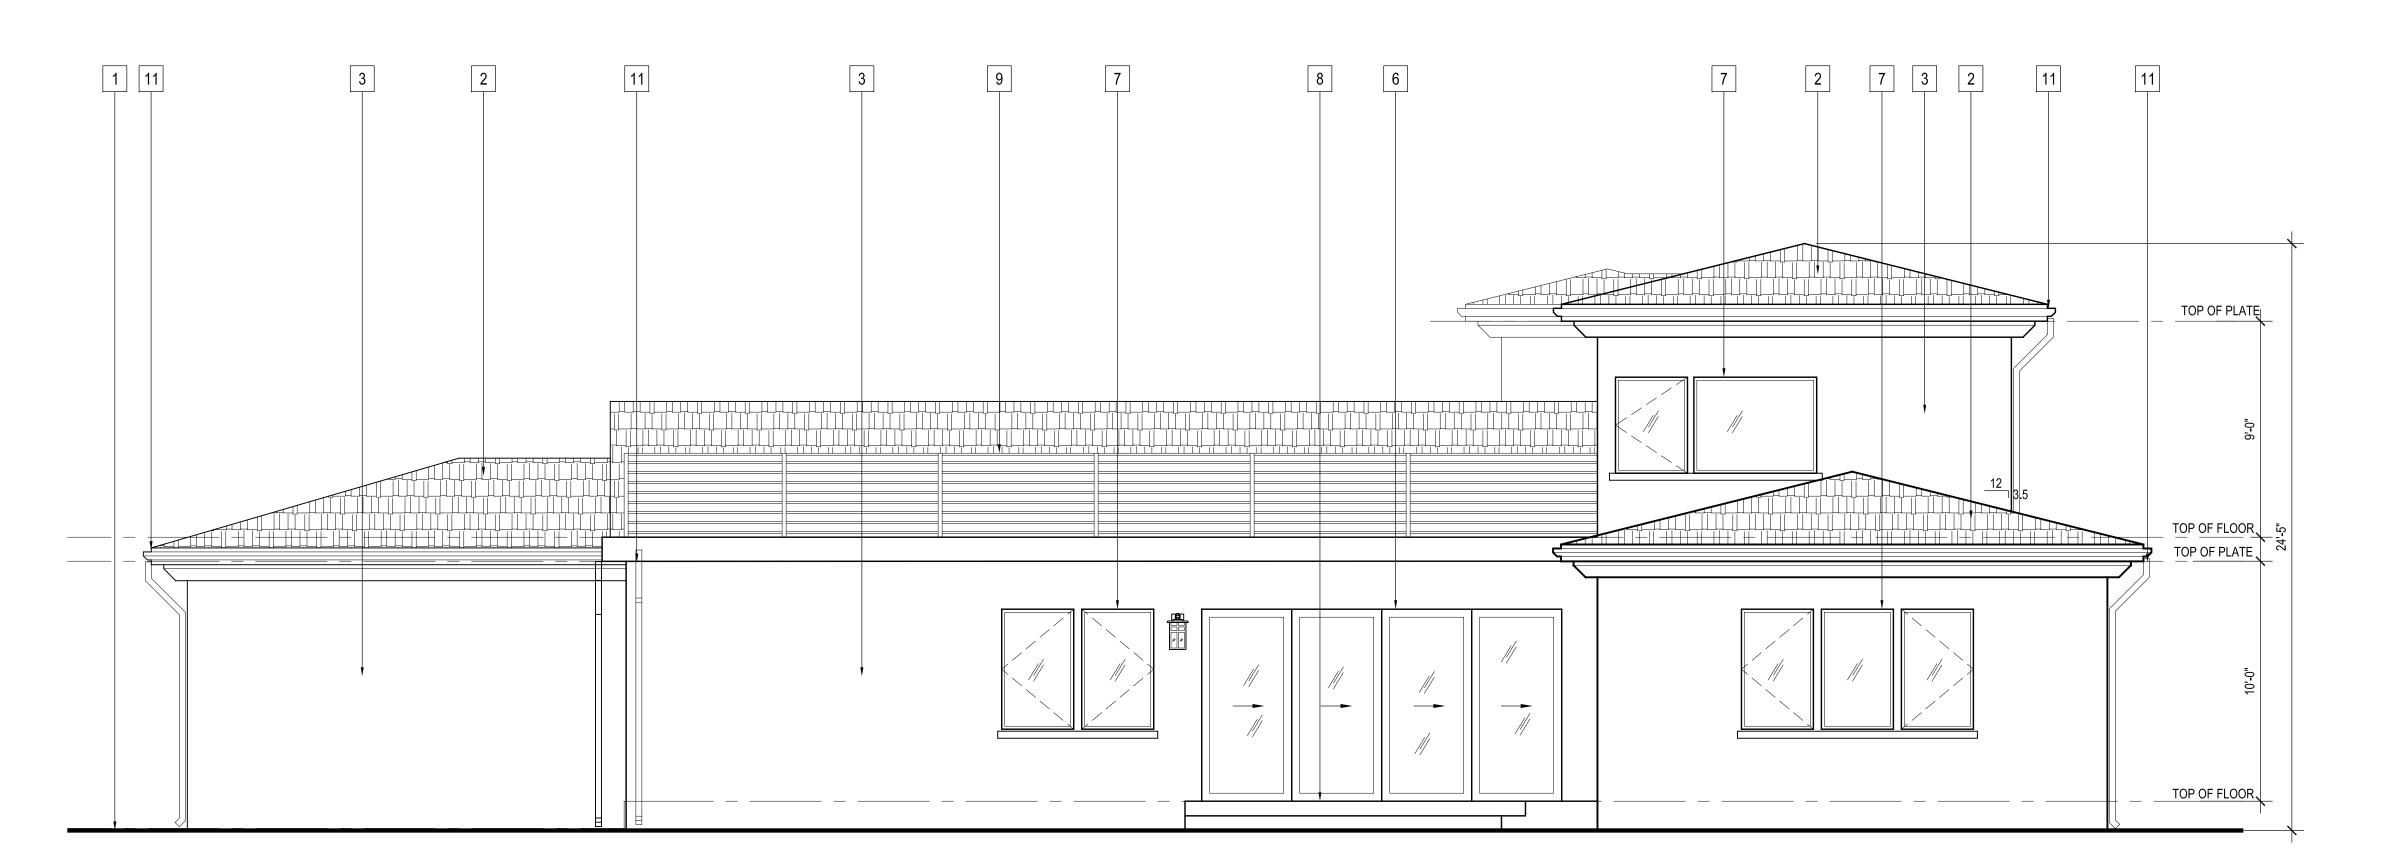
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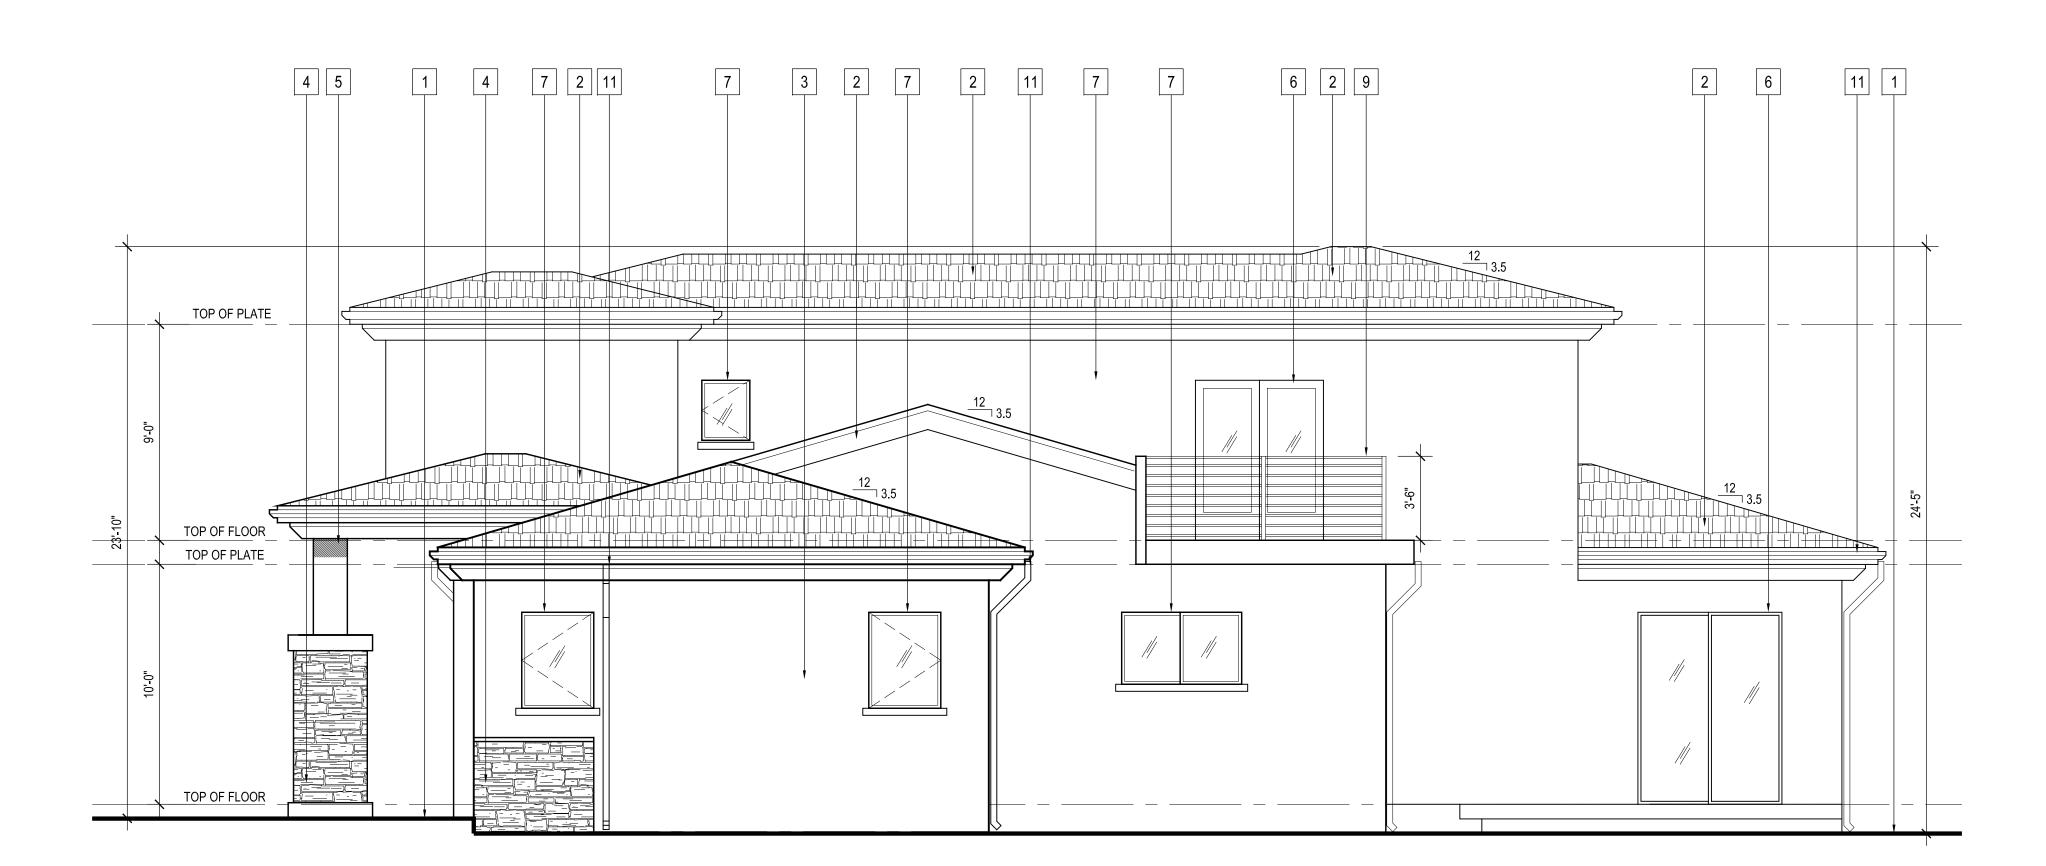
| DATE: | 04/2020 |
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A3.1



REAR (SOUTH) ELEVATION

SCALE : 1/4" = 1'-0"




WEST ELEVATION

SCALE : 1/4" = 1'-0"

ELEVATION KEYED NOTES

- 1. EXT'G GRADE
- 2. NEW CLASS 'A' ROOFING
- LIGHT WEIGHT CONCRETE
- 3. NEW 7/8" SMOOTH STUCCO
- 4. STONE VENEER
- 5. NEW COLUMN
- 6. NEW DOOR (SEE SCHEDULE)
- 7. NEW WINDOW (SEE SCHEDULE)
- 8. NEW CONC. LANDING (WITH STEPS)
- 9. NEW RAILING 42" MIN. HT.
 10. LIGHT FIXTURE
- 10. LIGHT FIXTO
- 11. DOWNSPOUT
- 12. STUCCO BAND
- 13. NEW CONC. WINDOW SILL 1-1/2" x 3"
- 14. NEW TRELLIS

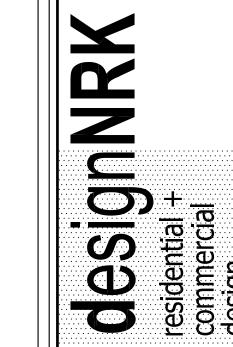


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 DATE:
 04/2020

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04/2020 20028 SHEET NO.



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GGSIGential + CSidential + CSid

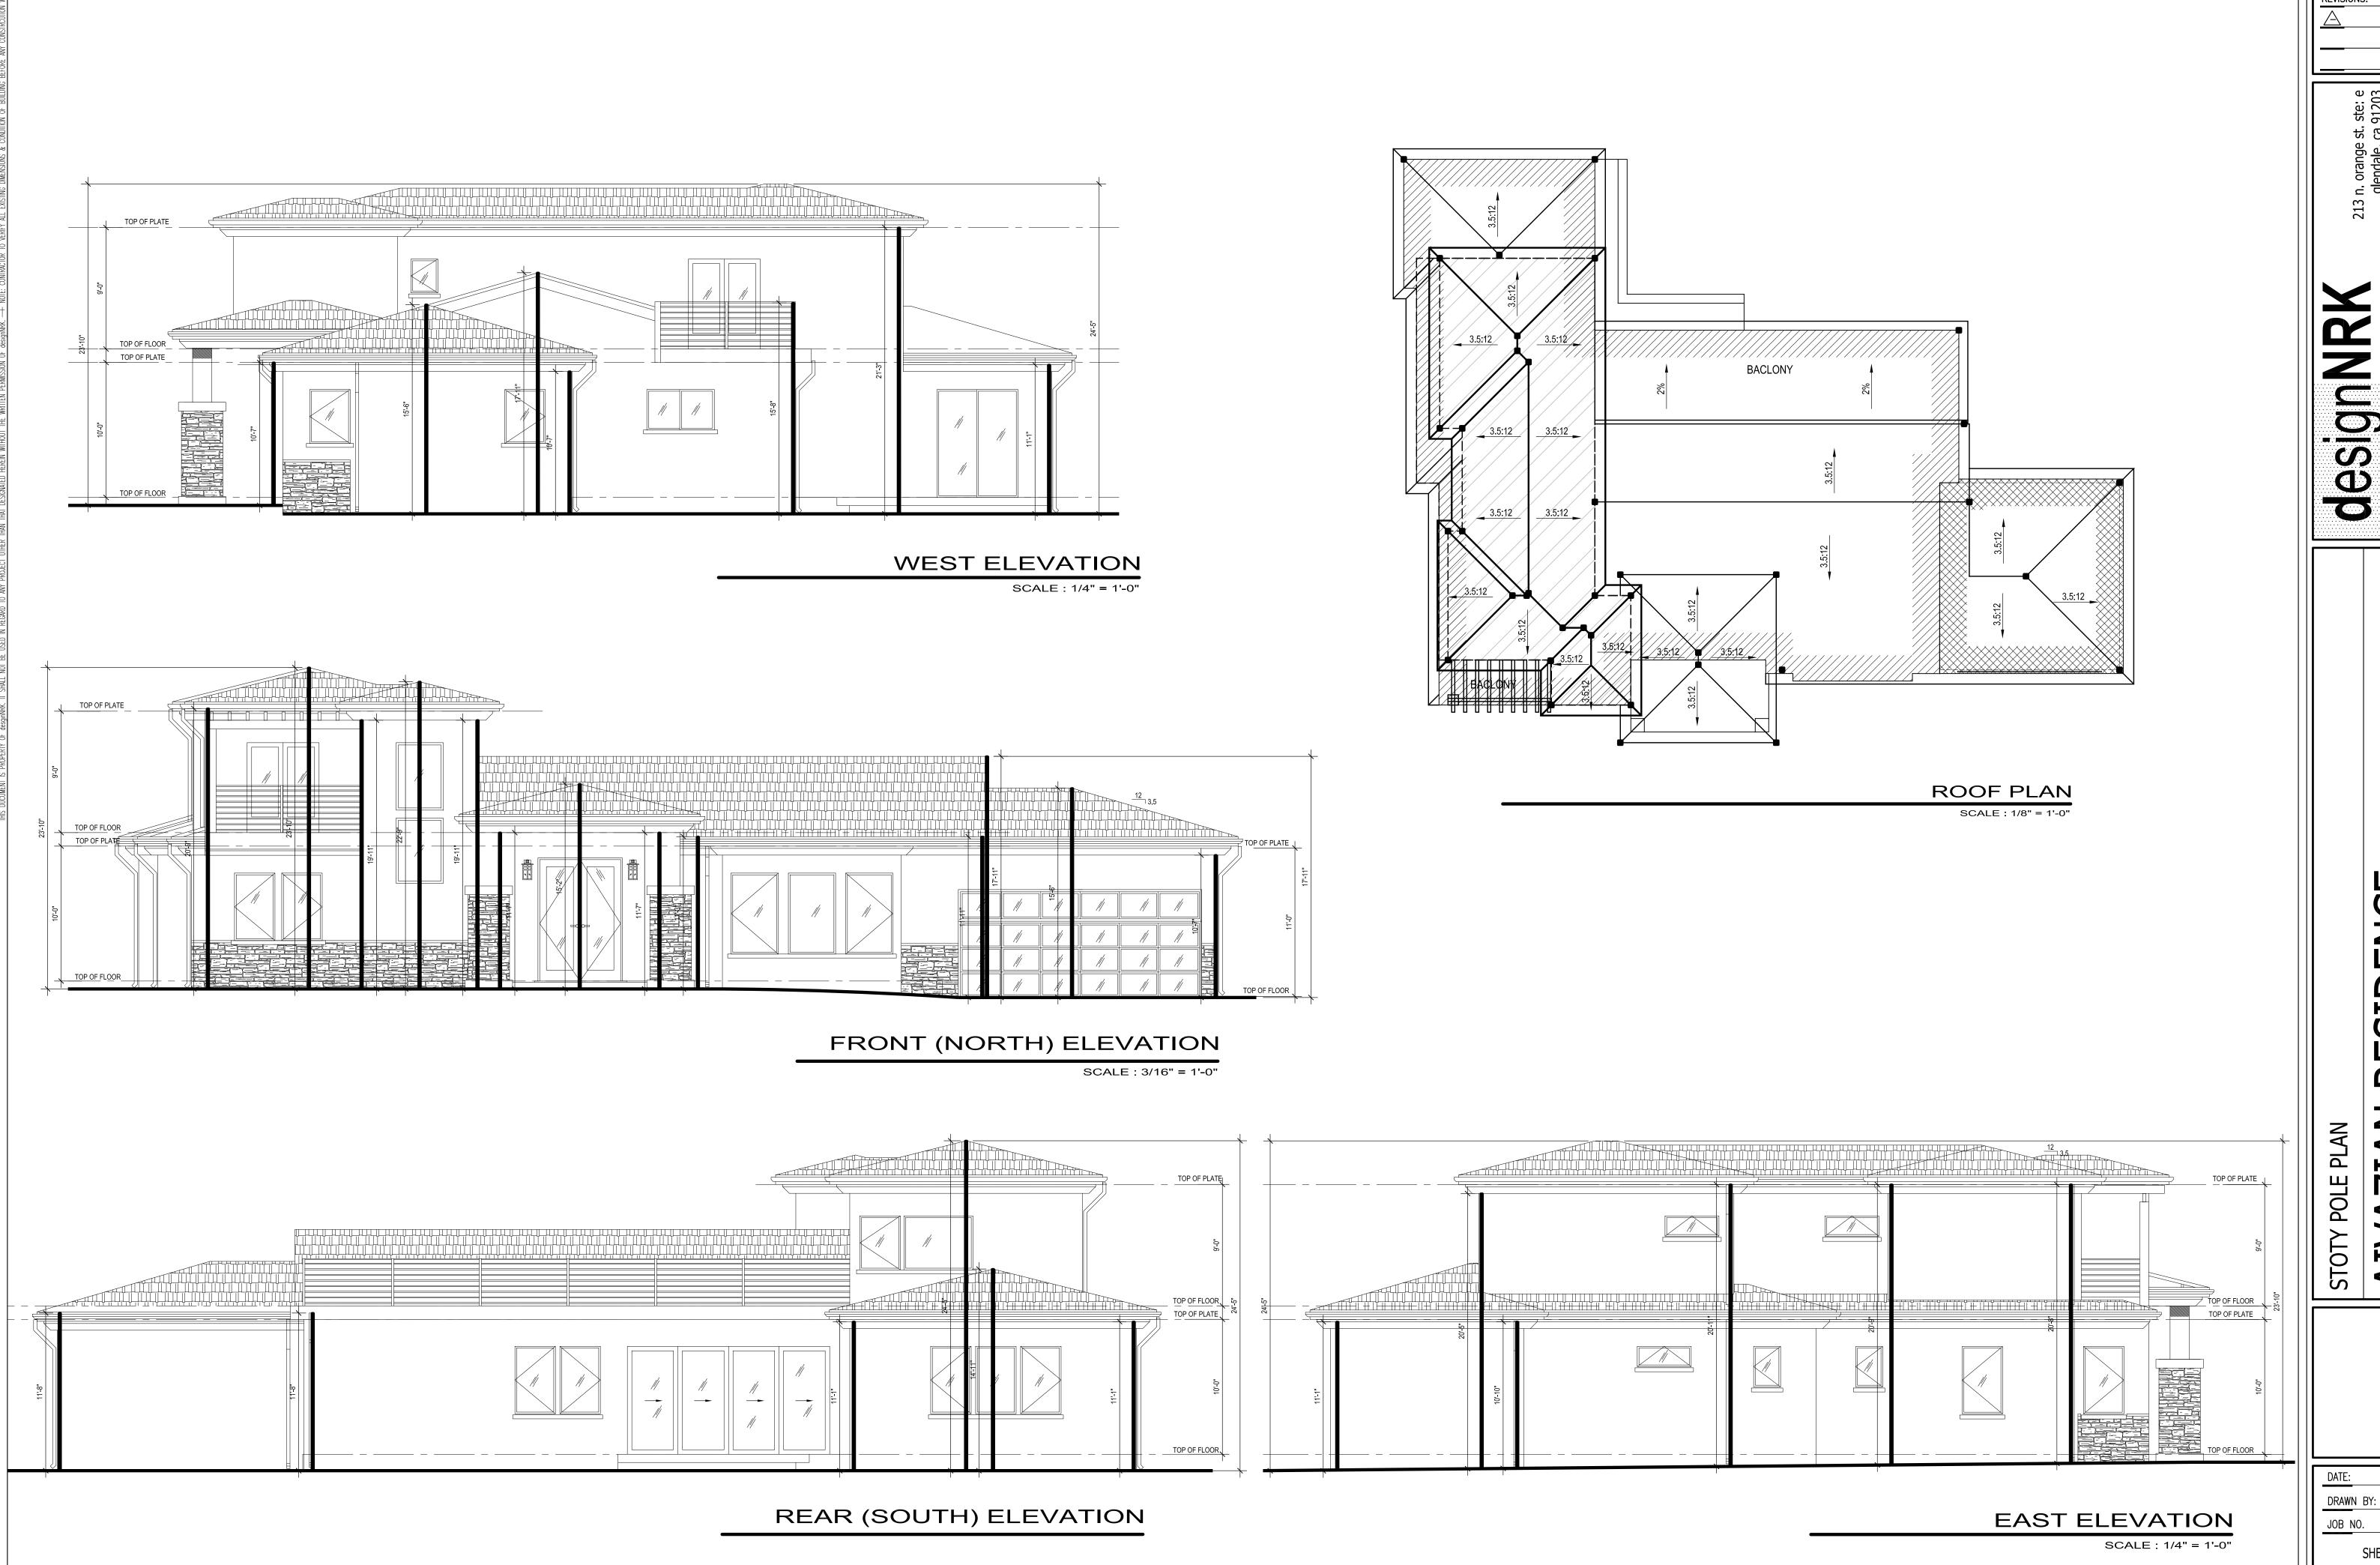AIVAZIAN RESIDENCE

 DATE:
 04/2020

 DRAWN BY:
 NRK

 JOB NO.
 20028

ELEVATION KEYED NOTES

- 1. EXT'G GRADE
- 2. NEW CLASS 'A' ROOFING
- LIGHT WEIGHT CONCRETE

 3. NEW 7/8" SMOOTH STUCCO
- 4. STONE VENEER
- F NEW CO
- 5. NEW COLUMN6. NEW DOOR (SEE SCHEDULE)
- 7. NEW WINDOW (SEE SCHEDULE)
- 8. NEW CONC. LANDING (WITH STEPS)
- 9. NEW RAILING 42" MIN. HT.
- 10. LIGHT FIXTURE
- 11. DOWNSPOUT
- 12. STUCCO BAND
- 13. NEW CONC. WINDOW SILL 1-1/2" x 3"
- 14. NEW TRELLIS





EAST ELEVATION

WEST ELEVATION





REAR (SOUTH) ELEVATION

FRONT (NORTH) ELEVATION

SCALE : 1/4" = 1'-0"

REVISIONS:

in. orange st. ste: e glendale, ca 91203 818.823.7286 o. 888.424.8125 f.

GCSIGENTIAL + Commercial

RESIDENCE

VAZIAN RESII


 DATE:
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ROOF: BORAL ROOF CO. SAXONY 900 SLATE - EBONY



STUCCO: DUNN EDWARDS COLOR: SWISS COFFEE



WINDOWS:
MILGARD FIBERGLASS
COLOR: BRONZE

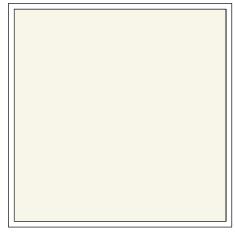

EXTERIOR STONE:
TETON GREY MANUFACTURED STONE
VENEER



RAILING: WROUGHT IRON COLOR: PAINTED BLACK



LIGHTING:


MODERN OUTDOOR LIGHTING
DESTINATION LIGHTING
COLOR: PAINTED BLACK



ENTRY DOOR: STEEL DOOR W/ FROSTED GLASS COLOR: PAINTED BLACK

924 OLD PHILLIPS RD. GLENDALE, CA 91207

DESIGNNRK 213 N. ORANGE ST. STE: E GLENDALE, CA 91203

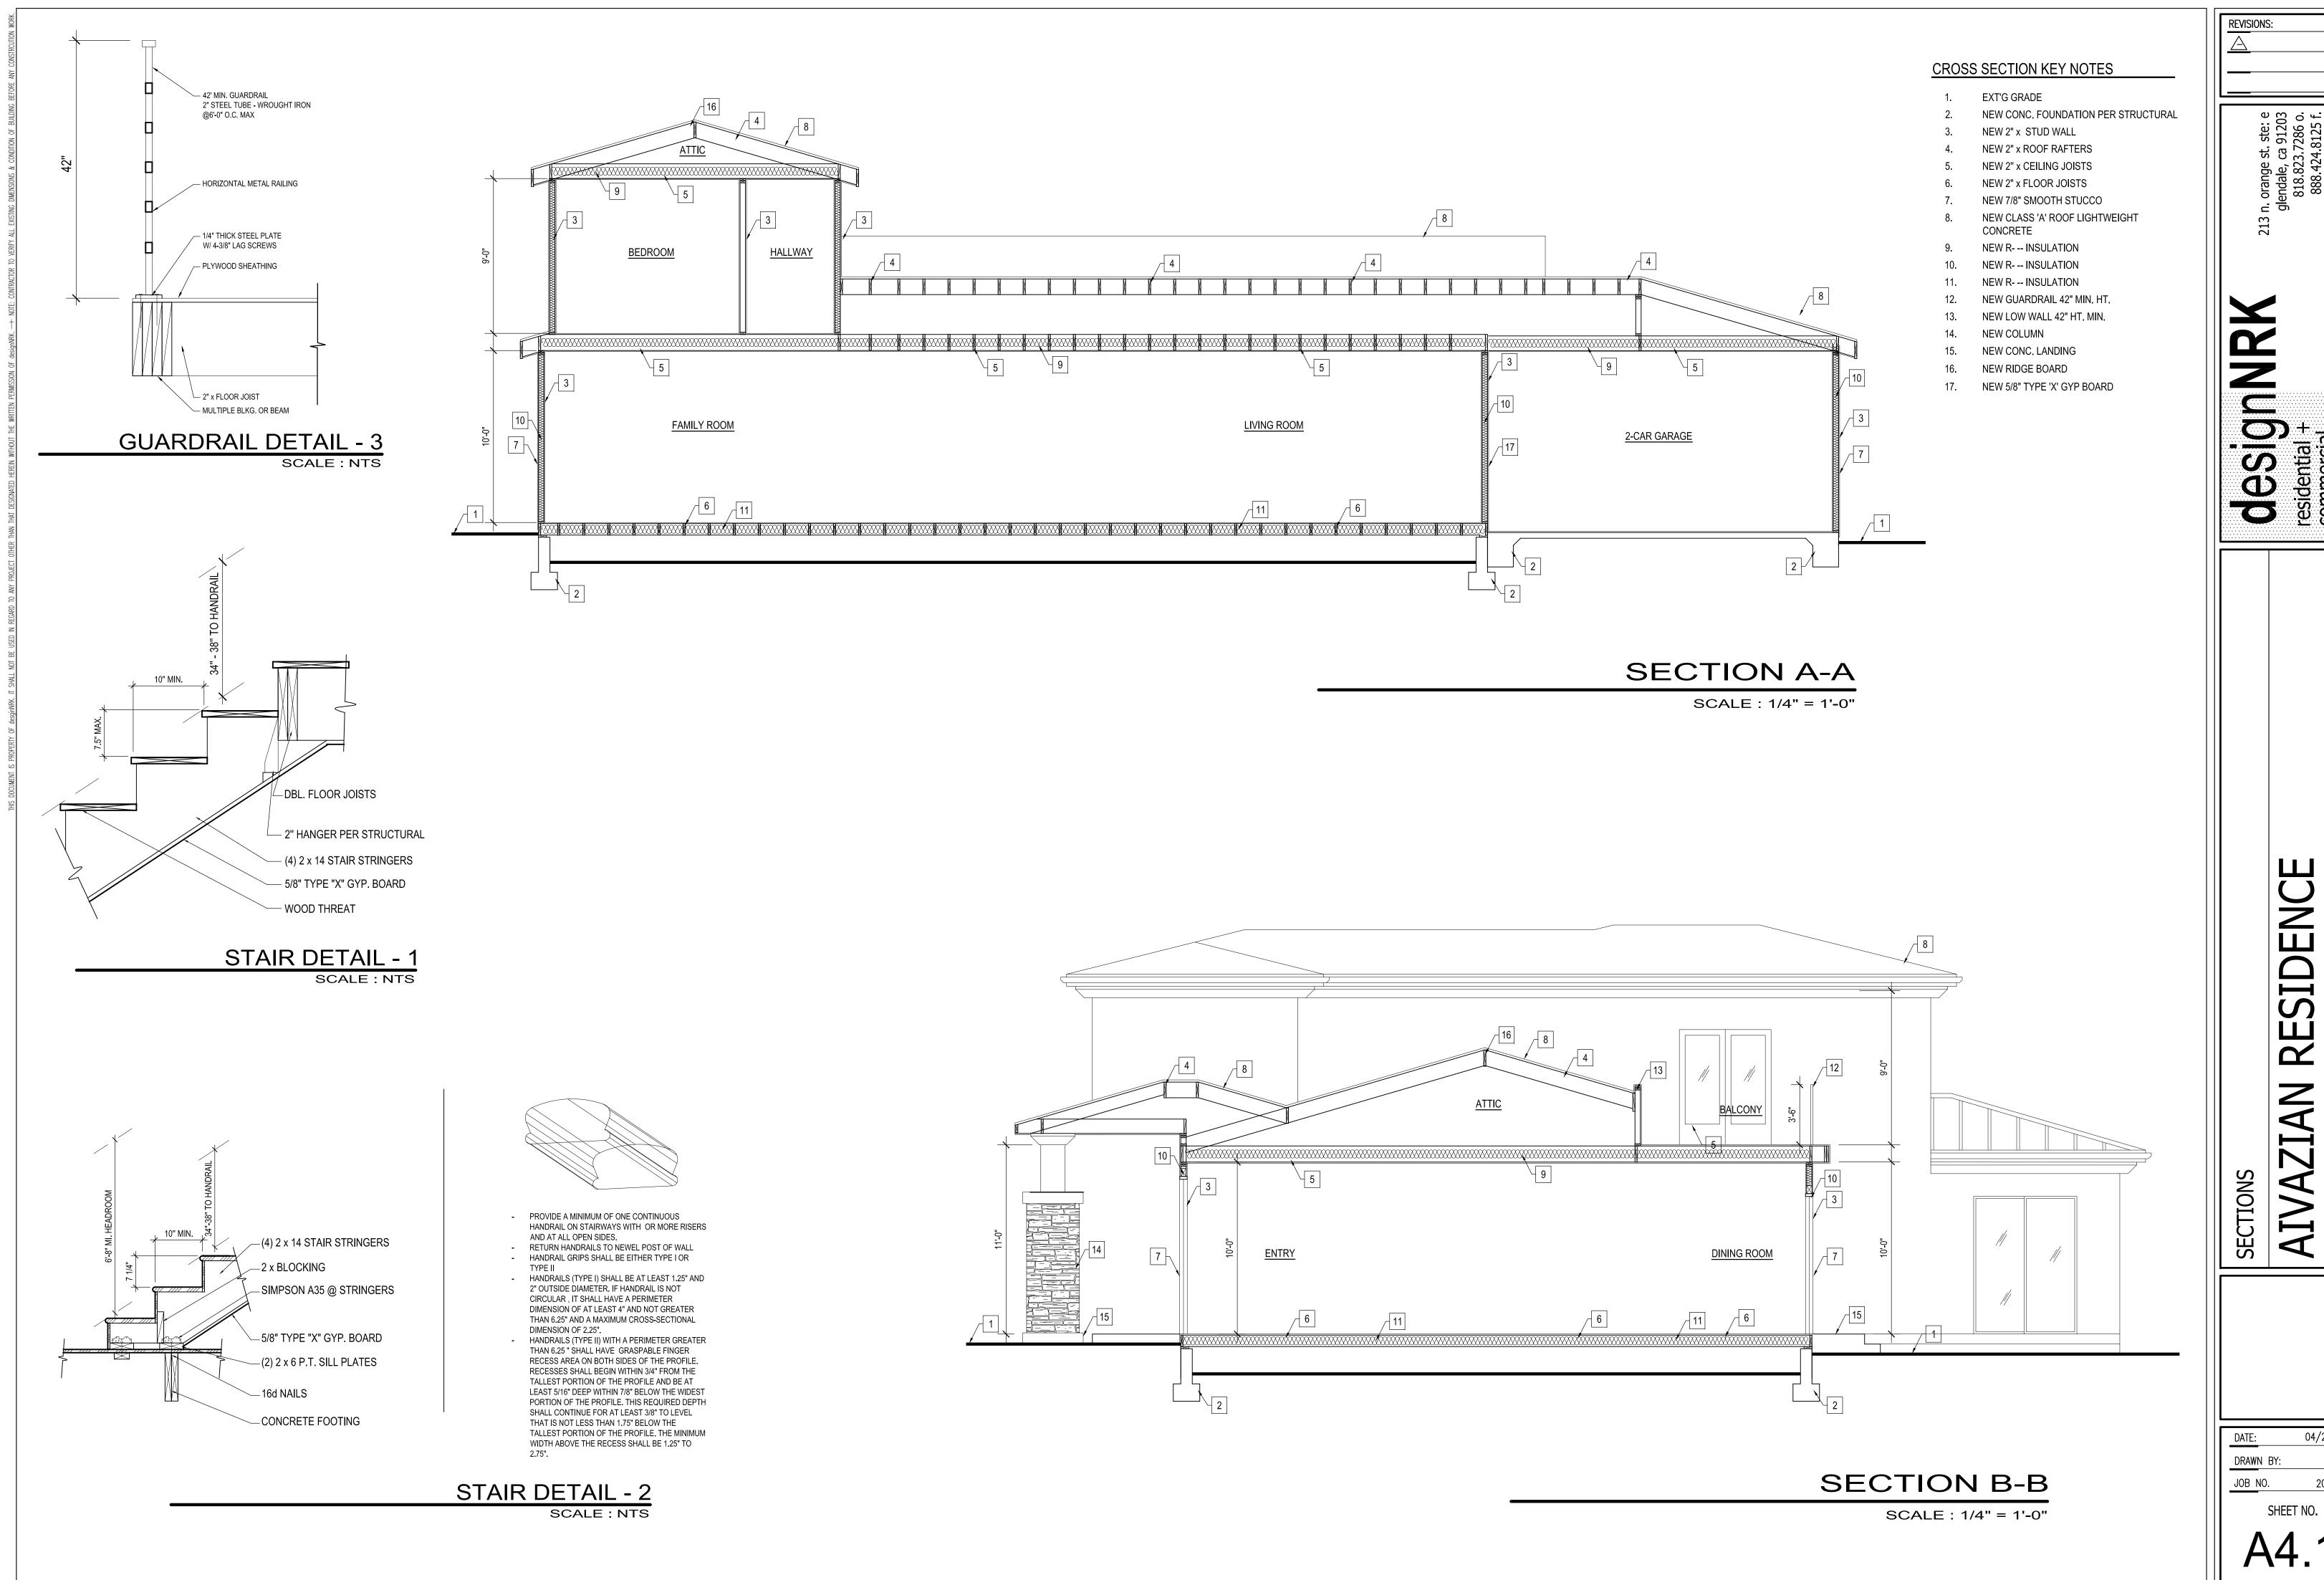

RESIDENC

04/2020 DRAWN BY: 20028

RESIDENTIAL REMODEL / ADDITION

924 OLD PHILLIPS RD. GLENDALE, CA 91207

PROJECT INFORMATION

PROJECT LOCATION 924 OLD PHILLIPS RD. GLENDALE, 91207


3 363 SQ. FT.

OLD PHILLIPS RD.


213 N. ORANGE STREET, STE. E GLENDALE, 91203 OFFICE: 818.823.7286

924 OLD PHILLIPS RD. GLENDALE, 91207

FAX: 888,424,8125 E-MAIL: INFO@DESIGNNRK.COM

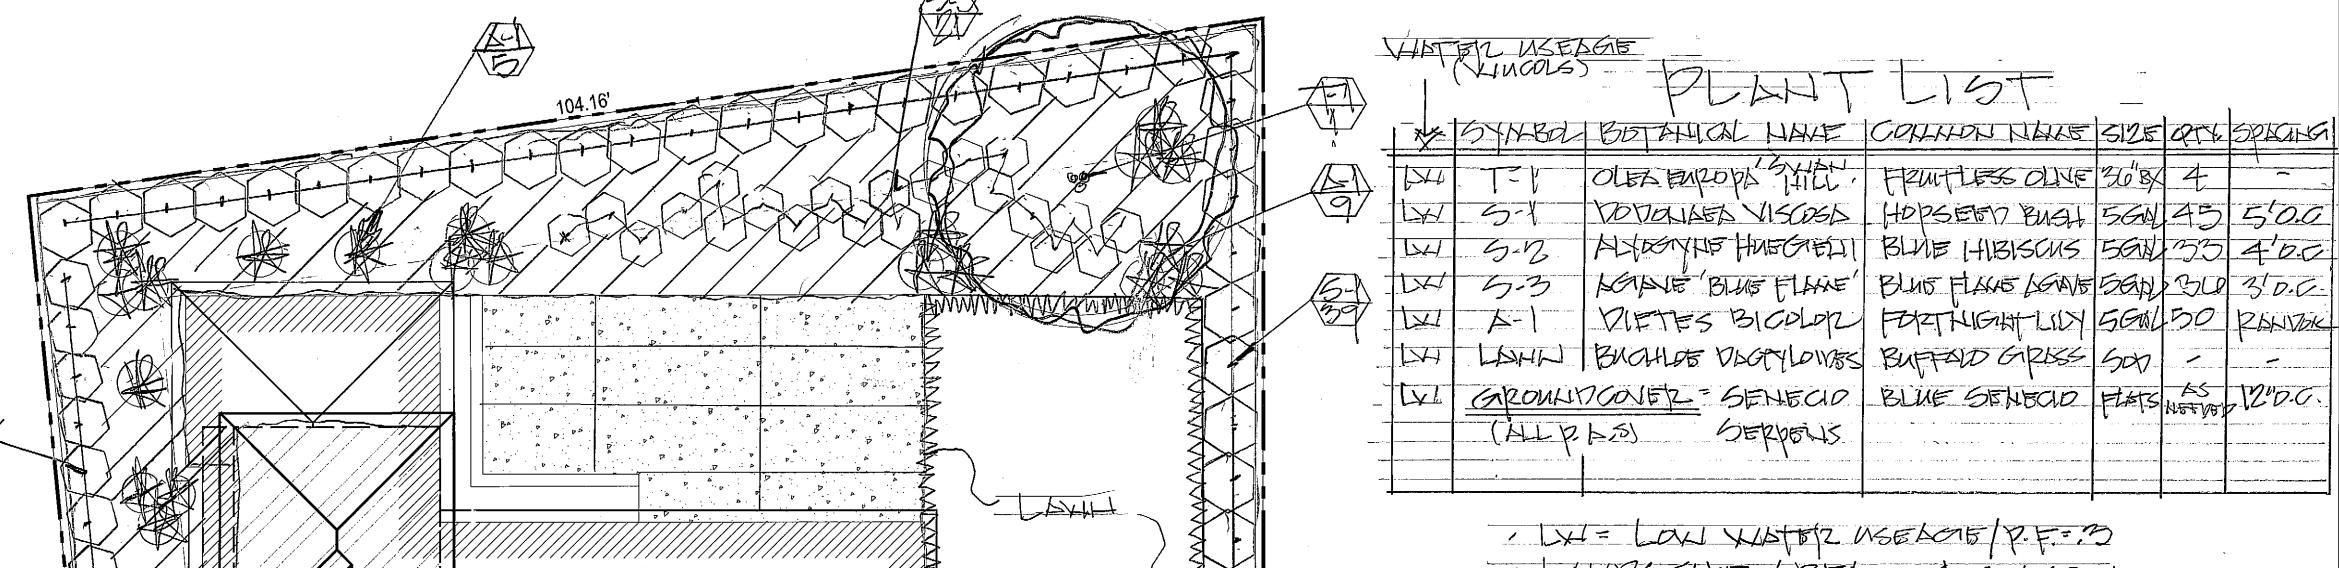

· LANDSCAPE AREA = 4, SULL SAFT

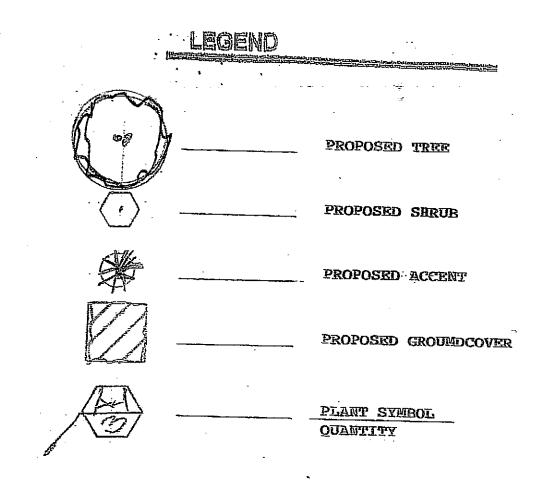

EXPOSED SOIL SURFACES OF PLANTING AREAS: EXCEPT FOR TURY AREAS, CREEPING OR ECOFING GROUNDCOVERS, OR DIRECT SEEDING. APPLICATIONS GEERE MULCE IS COMPRADICED. FOR SOITS LESS THAT 6% ORGANIC MATTER IN THE TOP 6"OF SOIL. COMPOST AT RATE OF A MINISUR OF 4 CUBIC YARDS SOIL PER 1,000 OF 6" INTO THE SOIL.

PLANTING PLAN




I HAVE COMPLIED WITH THE CRITERIA OF THE CALIFORNIA MODEL WATER ENFICIENT LANDSCAPE

ORDINANCE AND APPLIED THEM FOR THE ENTICHEMP USE OF WATER IN THE LANDSCAPE DESIGN PLAN.

LARRY G. TISON & ASSOCIATES
LARRY G. TISON, A.S.L.A. LANDSCAPE ARCHITECTURE
314 E. BROADWAY, SUITE D. GLENDALE, CALIFORNIA 91205

DATE: 8-24-21 DRAWN BY: LGT JOB NO.

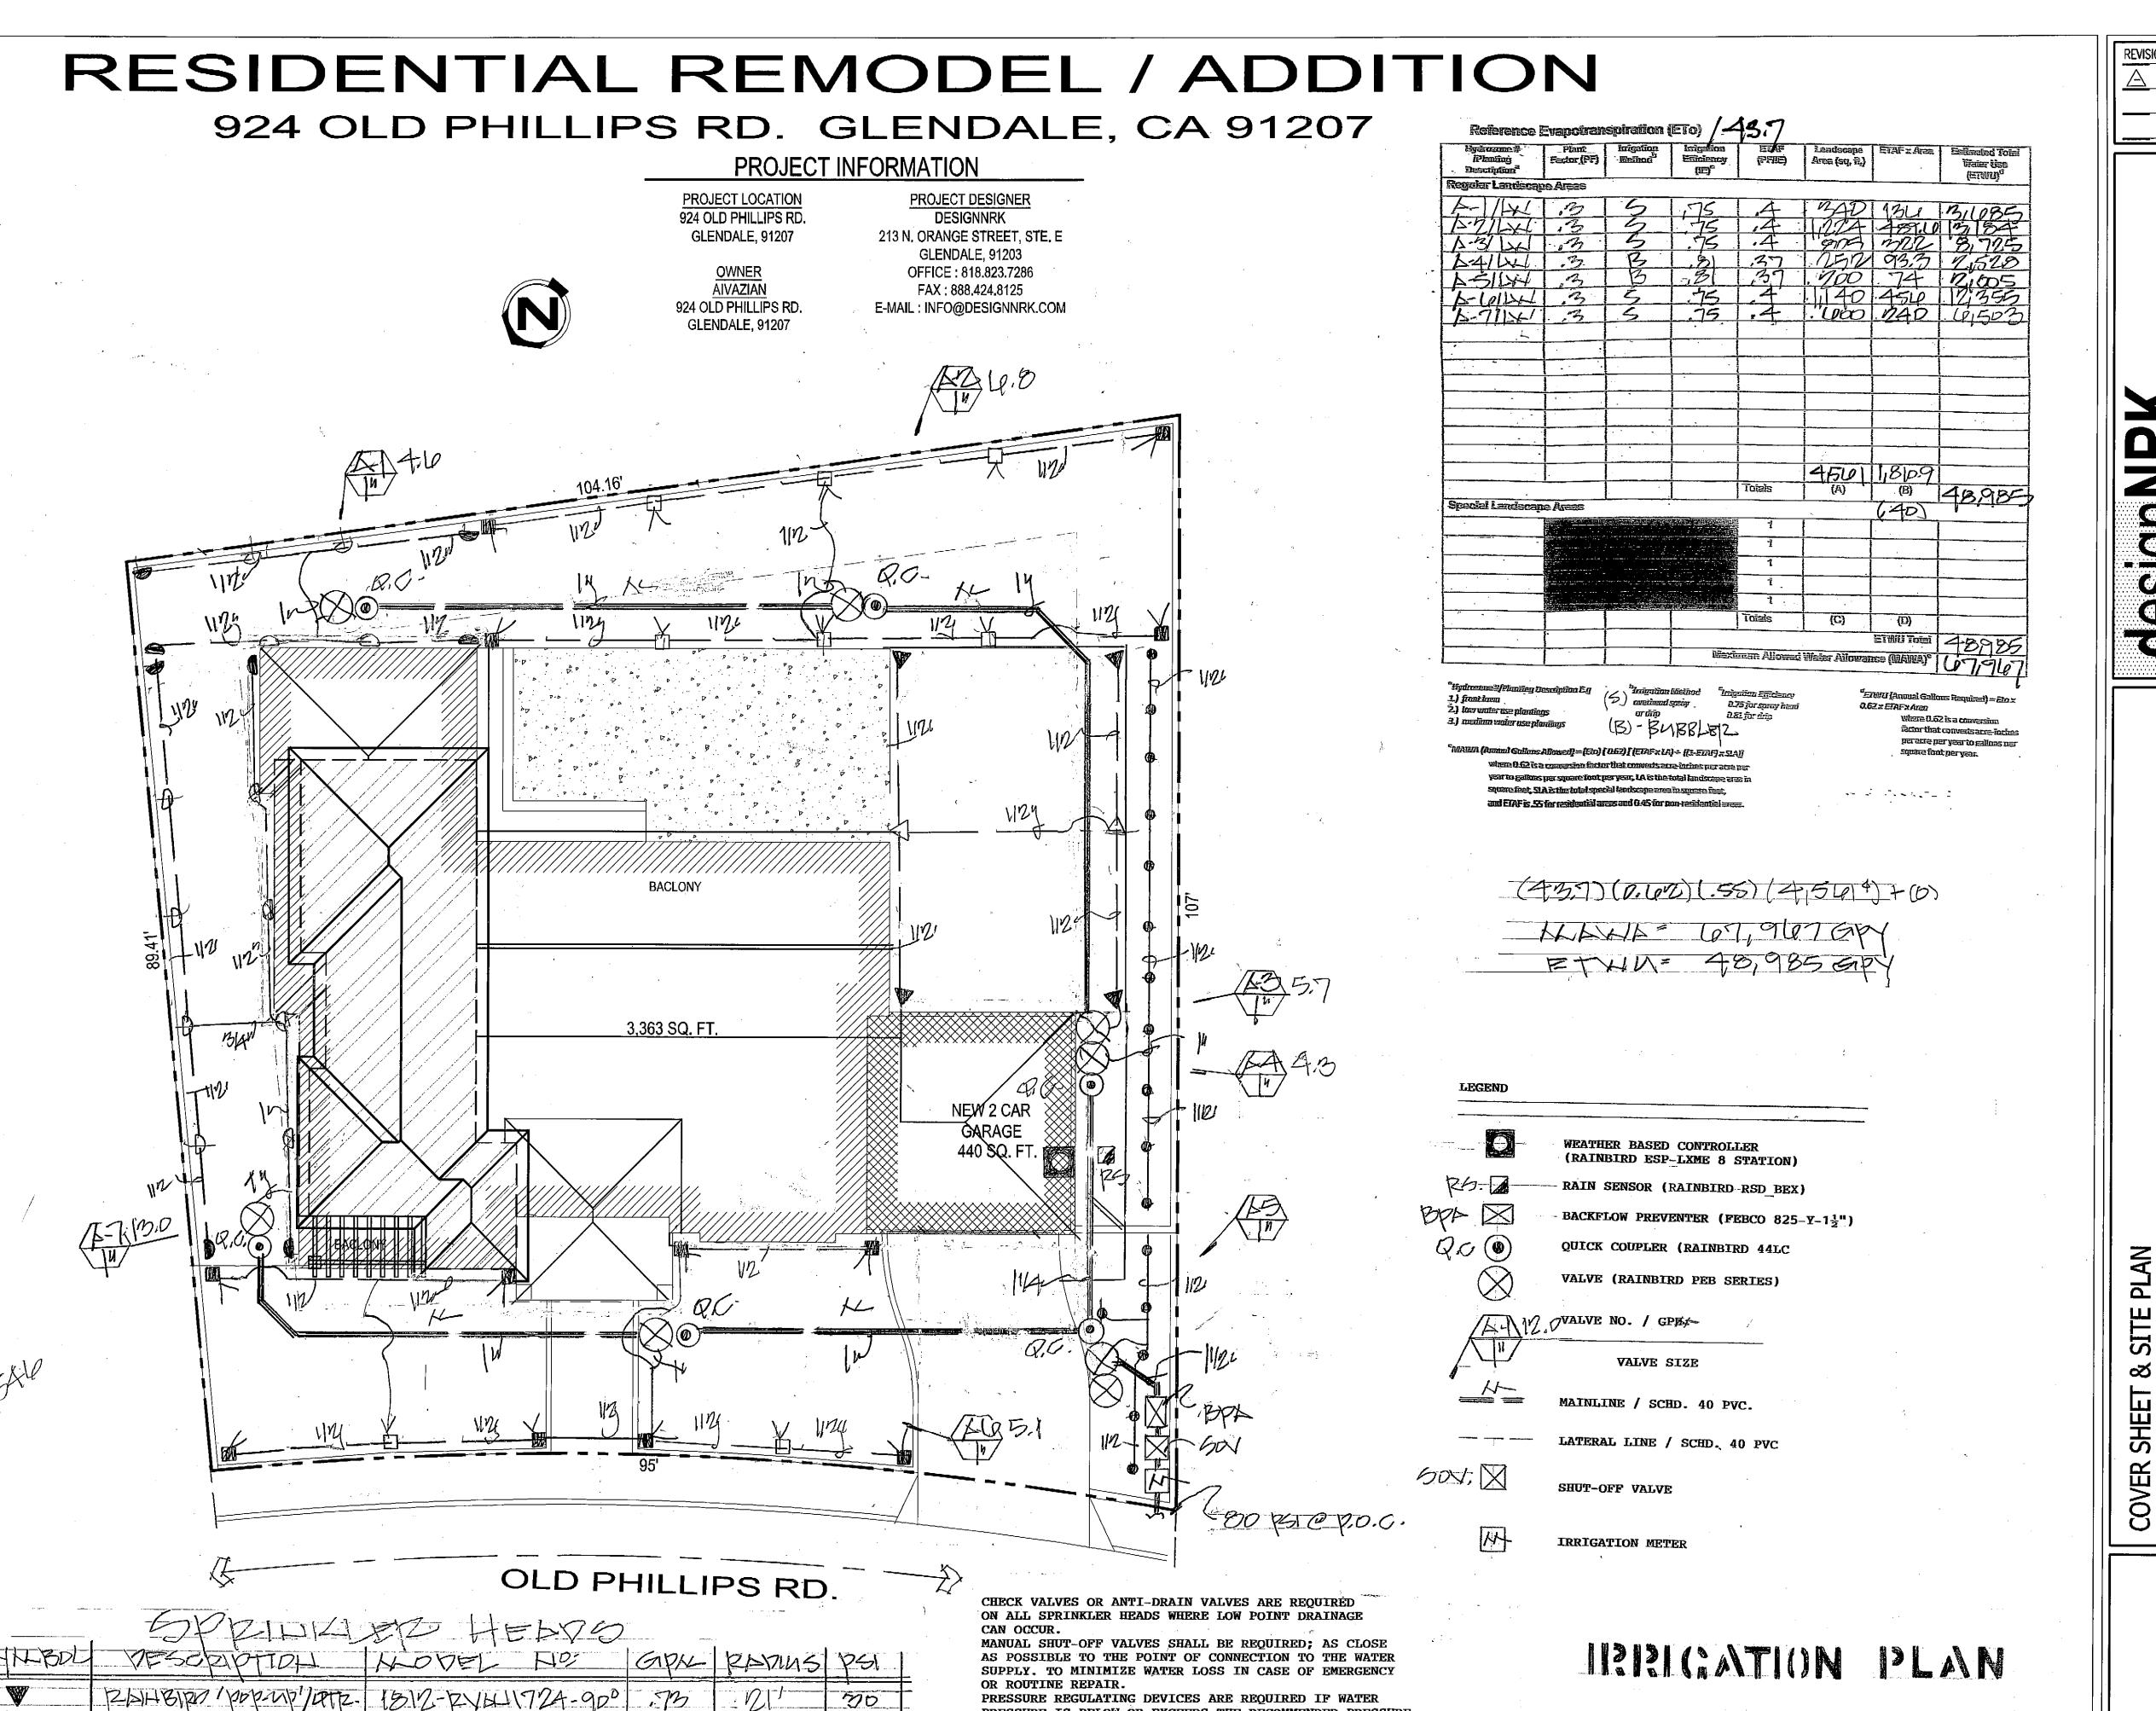

AND CERTIFIED BY EITHER DESIGNER OF THE LANDSCAPE

PLANS; IRRIGATION PLANS OR THE LICENSED LANDSCAPE

SCHEDULE OF LANDSCAPE AND IRRIGATION MAINTENANCE.

AT THE TIME OF THE FINAL INSPECTION; THE PERMIT APPLICANT

OF COMPLETION, CERTIFICATION OF INSTALLATION, IRRIGATION

CONTRACTOR FOR THE PROJECT.

1812-12VAH18-1800



LARRY G. TISON & ASSOCIATES
LARRY G. TISON, A.S.L.A.

LANDSCAPE ARCHITECTURE
314 E. BROADWAY, SUITE D, GLENDALE, CALIFORNIA 91205

DATE: 8-24-21

DRAWN BY: LOT

JOB NO. 20028

AIV,

